

SUBMITTAL

NO SPRINKLERS REQUIRED IN: CLOSETS 24 SQ.FT. OR LESS IN AREA PER NFPA 13R SECTION 6.6.3

PROJECT SQUARE FOOTAGES

LOWER LEVEL = 2530 SF MAIN LEVEL = 2970 SF UPPER LEVEL = 789 SF

	Nominal Pipe Size (in.)									
	3/4	1	11/4	11/2	2	21/2	3	4	6	8
Steel Pipe except threaded lightwall	N/A	12-0	12-0	15-0	15-0	15-0	15-0	15-0	15-0	15-0
Threaded lightwall steel pipe	N/A	12-0	12-0	15-0	15-0	15-0	15-0	N/A	N/A	N/A
Copper tube	8-0	8-0	10-0	10-0	12-0	12-0	12-0	15-0	15-0	15-0
CPVC	5-6	6-0	6-6	7-0	8-0	9-0	10-0	N/A	N/A	N/A

	PROJECT SUMMARY: PROJECT NAME:	ROWAN RESIDENCE
	PROJECT ADDRESS:	771 BURGUNDY RD, INCLINE VILLAGE, NV
	APN:	126-271-08
	PROJECT TYPE:	NEW T.I.
	TYPE OF CONSTRUCTION:	V
	OCCUPANCY GROUP(S):	R3
	OCCUPIED LEVELS:	3
	TOTAL SPRINKLERED AREA:	<u>6289</u> SQ. FT.
	NFPA CODE REQUIREMENT:	□NFPA 13 VNFPA 13R □NFPA 13D
	NUMBER OF SYSTEMS:	1
	SYSTEM TYPE(S):	■ WET MANTI-FREEZE ■ DRY ■ PREACTION
	TOTAL SPRINKLERS:	64
	SPECIAL NOTES:	SEE FIRE SPRINKLER NOTES THIS SHEET
l		


SPRINKLER SPACING

- A SINGLE PENDENT SPRINKLER IN A COMPARTMENT MAY BE SPACED AT A MAXIMUM OF 18'x 18' (324 SQ. FT.)
- OR UP TO 9' OFF A WALL. FOUR OR MORE HEADS IN A COMPARTMENT SHALL BE SPACED AT A MAXIMUM OF 18'x18'(324SQ. FT.) OR UP TO 9' OFF
- A WALL (MINIMUM 8'-0" BETWEEN SPRINKLERS) SPRINKLERS SHALL BE MEASURED AT PERPENDICULAR ANGLES

THIS FIRE SPRINKLER SYSTEM UTILIZES THE NOBLE COMPANY FIREFIGHTER ELIMINATOR ANTI-FREEZE SOLUTION


TO WALLS AND ALONG THE SLOPES OF CEILINGS.

SPRINKLER HEAT	ZONES:	
HEAT SOURCE:	ORDINARY TEMP SPRINKLER	INTERMEDIATE TEMP SPRINKLER
SIDE OF OPEN OR RECESSED FIRE PLACE	36"	12"
FRONT OF RECESSED FIRE PLACE	60"	36 "
COAL OR WOOD BURNING STOVE	42"	12"
RANGE/OVEN, HOT AIR FLUES & UNINSULATED HEAT DUCT	18"	9"
UNINSULATED HOT WATER PIPES & 250-499 WATT LIGHTS	12"	6"
SIDE OF CEILING OR WALL MOUNTED HOT AIR DIFFUSERS	24"	12"
FRONT OF WALL MOUNTED HOT AIR DIFFUSER		18"
HOT WATER HEATER, FURNACE, LIGHT FIXTURI 0—250 WATT	E 6"	3"

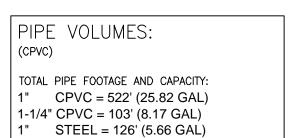


TOTAL VOLUME: ± 39.64 GALLONS


NFPA 13 - Table A.7.2.3 Capacity of 1 ft of pipe (Based on Actual Internal Pipe Diameter)								
Nominal Pipe Diameter (in.)	Pi Schedule 40 (gal)	CPVC						
1 1½ 1½ 2 2	0.045 0.078 0.106 0.174 0.248	0.049 0.085 0.115 0.190 0.283	0.049 0.079 0.104					

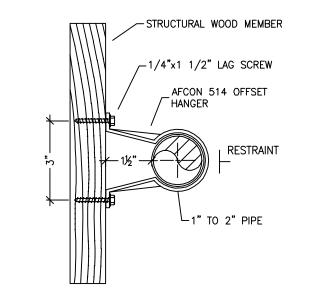

514 OFFSET HANGER


STEEL PIPE APPLICATION

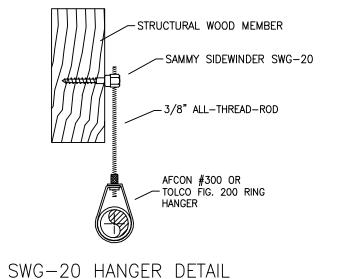

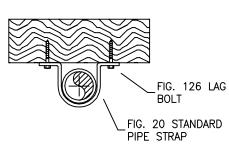


SIDE VIEW


STANDARD PIPE STRAP

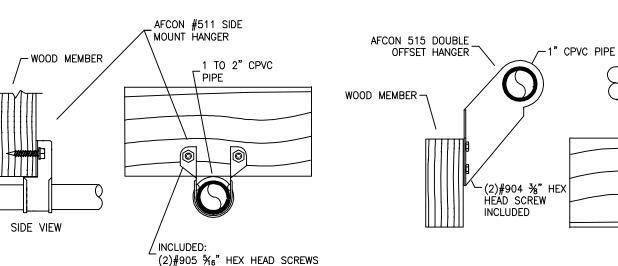

FOR HORIZONTAL ATTACHMENT TO WOOD

511 SIDE MOUNT HANGER 515 DOUBLE OFFSET HANGER CPVC PIPE APPLICATION

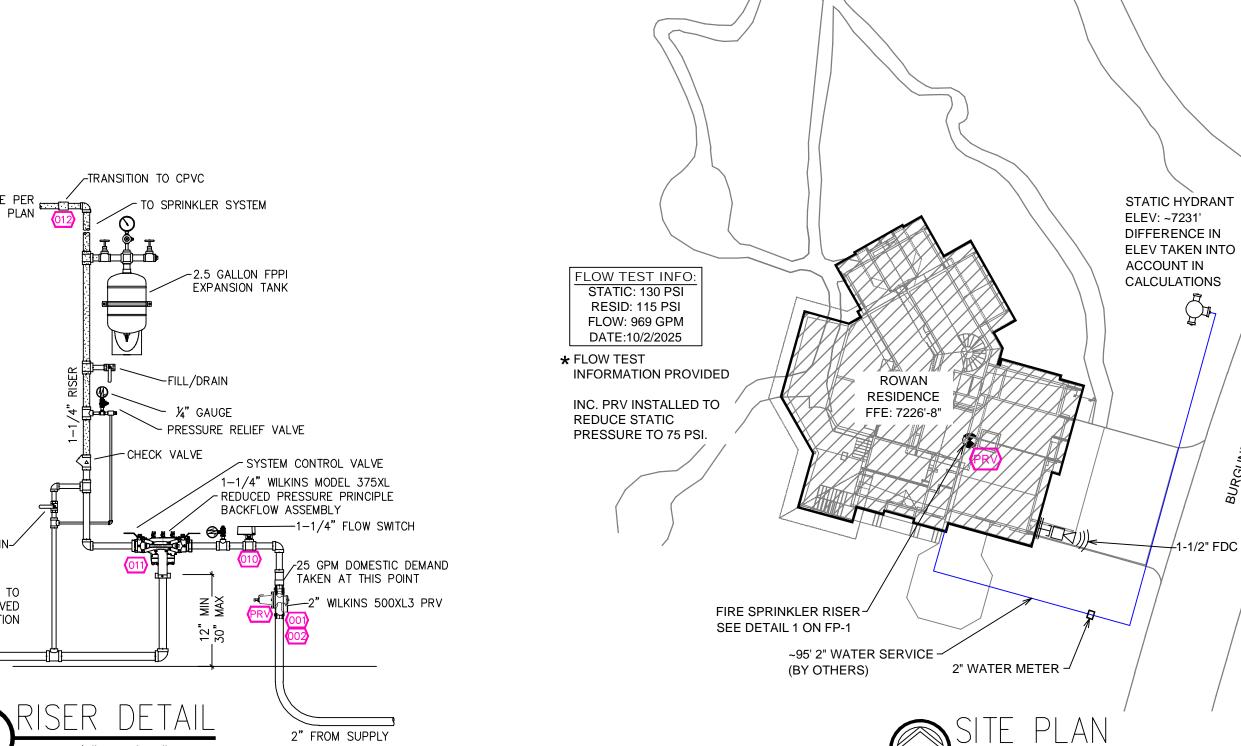

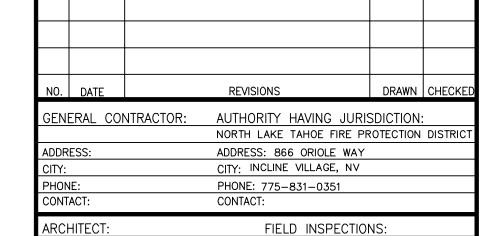

FIRE SPRINKLER NOTES:

- . THE PROPOSED FIRE SPRINKLER SYSTEM IS AN ANTI-FREEZE SYSTEM AND SHALL BE DESIGNED AND INSTALLED IN ACCORDANCE WITH NFPA 13R 2022 WITH MODIFICATIONS MANDATED BY THE AHJ AS FOLLOWS: SPRINKLER PROTECTION FOR BALCONIES, DECKS, PATIOS & OTHER
- OVERHANGS OVER 4'-0". 4 HEAD CALCULATION
- ANTIFREEZE TESTPORT 2. THIS SPRINKLER SYSTEM IS HYDRAULICALLY CALCULATED IN ACCORDANCE WITH NFPA 13R TO PROVIDE 0.05 GPM PER SQ. FT. OVER
- THE MOST REMOTE AREA. B. THE NUMBER OF DESIGN SPRINKLERS SHALL INCLUDE ALL SPRINKLERS
- WITHIN A COMPARTMENT UP TO A MAXIMUM OF 4 SPRINKLERS 4. ALL SPRINKLER PIPING CONCEALED ABOVE CEILINGS SHALL BE CPVC PIPING UNLESS OTHERWISE NOTED.
- 5. ALL DIMENSIONS SHOWN ARE CENTER TO CENTER U.O.N. 6. ALL HANGERS SHALL BE INSTALLED IN ACCORDANCE WITH NFPA 13R
- AND/OR NFPA 13 REQUIREMENTS. 7. HOLES THROUGH SOLID STRUCTURAL MEMBERS SHALL BE PERMITTED
- TO SERVE AS HANGERS FOR THE SUPPORT OF SYSTEM PIPING. 8. ALL SYSTEM PIPING SHALL BE TESTED FOR LEAKAGE AT NORMAL SYSTEM OPERATING PRESSURE.
- 9. THE OWNER SHALL BE RESPONSIBLE FOR MAINTAINING A MINIMUM TEMPERATURE OF 40° FAHRENHEIT TO PROTECT FROM FREEZING, THE SECTIONS OF THE SPRINKLER SYSTEM WHERE THERE IS NO ANTI-FREEZE IN THE PIPING (UPSTREAM OF THE RISER).

_									
SPRINKLER HEAD LEGEND									
SYM	QTY	TYPE	MFG.	MODEL#	NPT	к	TEMP	FINISH	S.I.N.
•	43	CONCEALED	SENJU	RC-RES	1/2"	4.9	162	WHITE	SS8464
◙	13	EXPOSED	SENJU	RC-RES	1/2"	4.9	205	BRASS	SS8464
(8)	6	SEMI-RECESS	SENJU	FR-RES	1/2"	4.9	205	WHITE	SS4451
(A)	1	CONCEALED	SENJU	RC-RES	1/2"	4.9	205	WHITE	SS8464
® ^	1	SEMI-RECESS	SENJU	FR-QR	1/2"	5.6	286	WHITE	SS2551

64 TOTAL SPRINKLERS

FIRE SPRINKLER SYMBOLS

AUTOMATIC SPRINKLER RISER *13" ELEV. BELOW DECK OR TOS +12'-9" ELEV. ABOVE FINISHED FLOOR

EARTHQUAKE BRACING 2-WAY & 4-WAY

----- CHANGE ELEVATION UP ₽ PIPE HANGER & ── CHANGE ELEVATION DN TYPE DESIGNATION —

♣ INSPECTORS TEST HYDRAULIC REF PT


← GRVD OR THRD CAP -- GRVD COUPLING TYPICAL POINT OF

CONNECTION (POC)

📤 LOCAL ALARM

⚠ REVISION NOTATION

—₩ AUX DRAIN

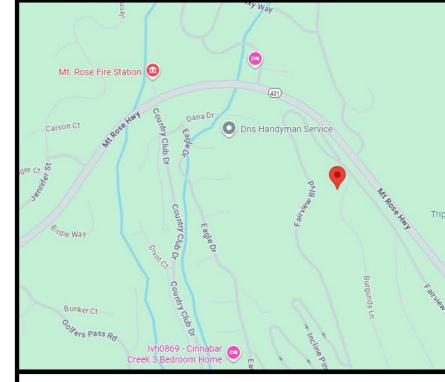

FIRE SPRINKLER PLANS FOR PROJECT NAME:

> **ROWAN RESIDENCE** 771 BURGUNDY RD INCLINE VILLAGE, NV 89451

STAMP:

—∕1-1/2" FDC & BELL

DRAWING TITLE: FIRE SPRINKLER PLAN

SCALE: 1/8"=1'-0" JOB NO.: 25-5043 DWG NO.: FP-1 BORN ON DATE: 10/16/2025 SHEET <u>1</u> OF <u>2</u>

