


## HANGER DETAILS

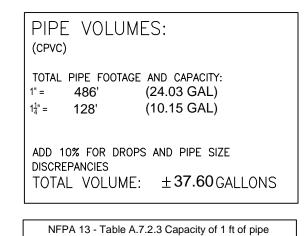


INCLUDED

515 DOUBLE OFFSET HANGER

SIDE VIEW

Pipe Nominal Pipe Schedule 40 Schedule 10 CPVC						
Diameter (in.)						
1	0.045	0.049	0.04			
11/4	0.078	0.085	0.07			
11/2	0.106	0.115	0.10			
2	0.174	0.190				
21/2	0.248	0.283				

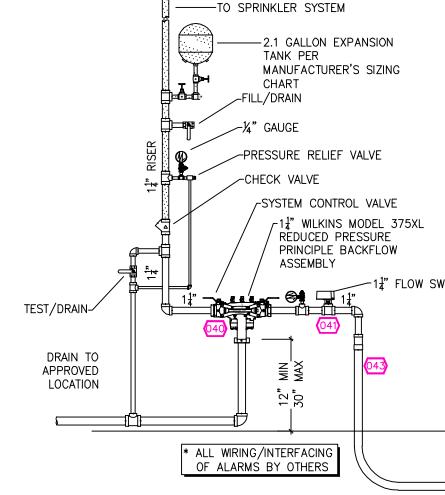

TRANSITION TO CPVC

SIZE PER PLAN

1" WATER

SERVICE -

PROPERTY LINE PUBLIC RIGHT OF WAY

\_ 2" TO FIRE SERVICE

UNDERGROUND WATER MAIN

2. 1" SERVICE SADDLE

6. 1" COMPRESSION FITTING

11. 1" PE OR TYPE "K" COPPER 12. 2" TO 1" REDUCER

7. 1" PE OR COPPER PIPE (IPS)

8. 1" CURB BALL VALVE (WITH RISER) 9. 1" COMPRESSION FITTING

3. LOCATOR WIRE

4. 1"x1"x1" TEE 5. 1" CORP. STOP

10. 2" STREET ELL

13. 2" BRASS NIPPLE 14. 2" RESILIENT WEDGE G.V. 15. MUELLER METER BOX

SF	PRINKLER SPACING
1.	A SINGLE PENDENT SPRINKLER MAY BE SPACED AT A MAXIMUM OF 18'x18'(324'SQ. FT.) OR UP TO 9' OFF A WALL. (MINIMUM 8'-0" BETWEEN SPRINKLERS)
2.	TWO OR MORE HEADS IN A COMPARTMENT SHALL BE SPACED AT A MAXIMUM OF 16'x16'(256'SQ. FT.) OR UP TO 8' OFF A WALL. (MINIMUM 8'-0" BETWEEN SPRINKLERS)
3.	· ·
TH	IS FIRE SPRINKLER SYSTEM UTILIZES

SUBMITTAL

NO SPRINKLERS REQUIRED IN:

PROJECT SQUARE FOOTAGES

LOWER LEVEL = 1,907 S.F.

MAIN LEVEL = 2,788 S.F.

UPPER LEVEL = 1,242 S.F.

SIDE VIEW

/ INCLUDED:

511 SIDE MOUNT HANGER CPVC PIPE APPLICATION

(2)#905 5/16" HEX HEAD SCREWS

THE NOBLE COMPANY FIREFIGHTER ELIMINATOR ANTI-FREEZE SOLUTION

NFPA 13 - Table 9.2.2.1(a) Maximum Distance Between Hangers (ft-in.)										
				Nor	minal F	Pipe S	ize (in.	)		
	3/4	1	11/4	11/2	2	21/2	3	4	6	8
Steel Pipe except threaded lightwall	N/A	12-0	12-0	15-0	15-0	15-0	15-0	15-0	15-0	15-0
Threaded lightwall steel pipe	N/A	12-0	12-0	15-0	15-0	15-0	15-0	N/A	N/A	N/A
Copper tube	8-0	8-0	10-0	10-0	12-0	12-0	12-0	15-0	15-0	15-0
CPVC	5-6	6-0	6-6	7-0	8-0	9-0	10-0	N/A	N/A	N/A


SPRINKLER HEAT	ZONES:	
HEAT SOURCE:	ORDINARY TEMP SPRINKLER	INTERMEDIATE TEMP SPRINKLER
SIDE OF OPEN OR RECESSED FIRE PLACE	36"	12"
FRONT OF RECESSED FIRE PLACE	60"	36"
COAL OR WOOD BURNING STOVE	42"	12 <b>"</b>
RANGE/OVEN, HOT AIR FLUES & UNINSULATED HEAT DUCT	18"	9"
UNINSULATED HOT WATER PIPES & 250-499 WATT LIGHTS	12"	6"
SIDE OF CEILING OR WALL MOUNTED HOT AIR DIFFUSERS	24"	12"
FRONT OF WALL MOUNTED HOT AIR DIFFUSE	RS 36"	18"
HOT WATER HEATER, FURNACE, LIGHT FIXTUR 0-250 WATT	RE 6"	3"




BUILDING SECTION

SCALE: 1/8" = 1'-0"

DDOIECT CHMMADY.					
PROJECT SUMMARY:					
PROJECT NAME:	MEYERS RESIDENCE				
PROJECT ADDRESS:	9259 BRAE CT, TRUCKEE, CA 96161				
APN:	107-240-009				
PROJECT TYPE:	MEW ☐ T.I.				
TYPE OF CONSTRUCTION:	_V-B				
OCCUPANCY GROUP(S):	R3				
OCCUPIED LEVELS:	3				
TOTAL SPRINKLERED AREA:	<u>4145</u> SQ. FT.				
NFPA CODE REQUIREMENT:	□NFPA 13 □NFPA 13R <b>1</b> NFPA 13D				
NUMBER OF SYSTEMS:	1				
SYSTEM TYPE(S):	□WET MANTI-FREEZE □DRY □PREACTION				
TOTAL SPRINKLERS:	_60				
SPECIAL NOTES:	SEE FIRE SPRINKLER NOTES THIS SHEET				

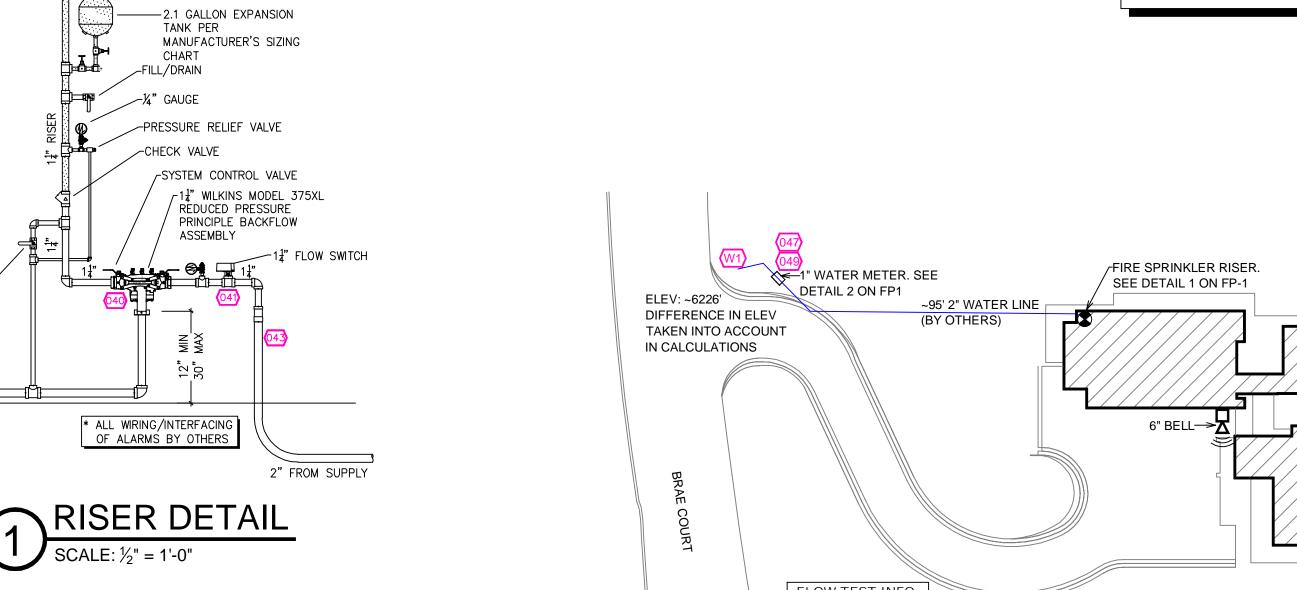

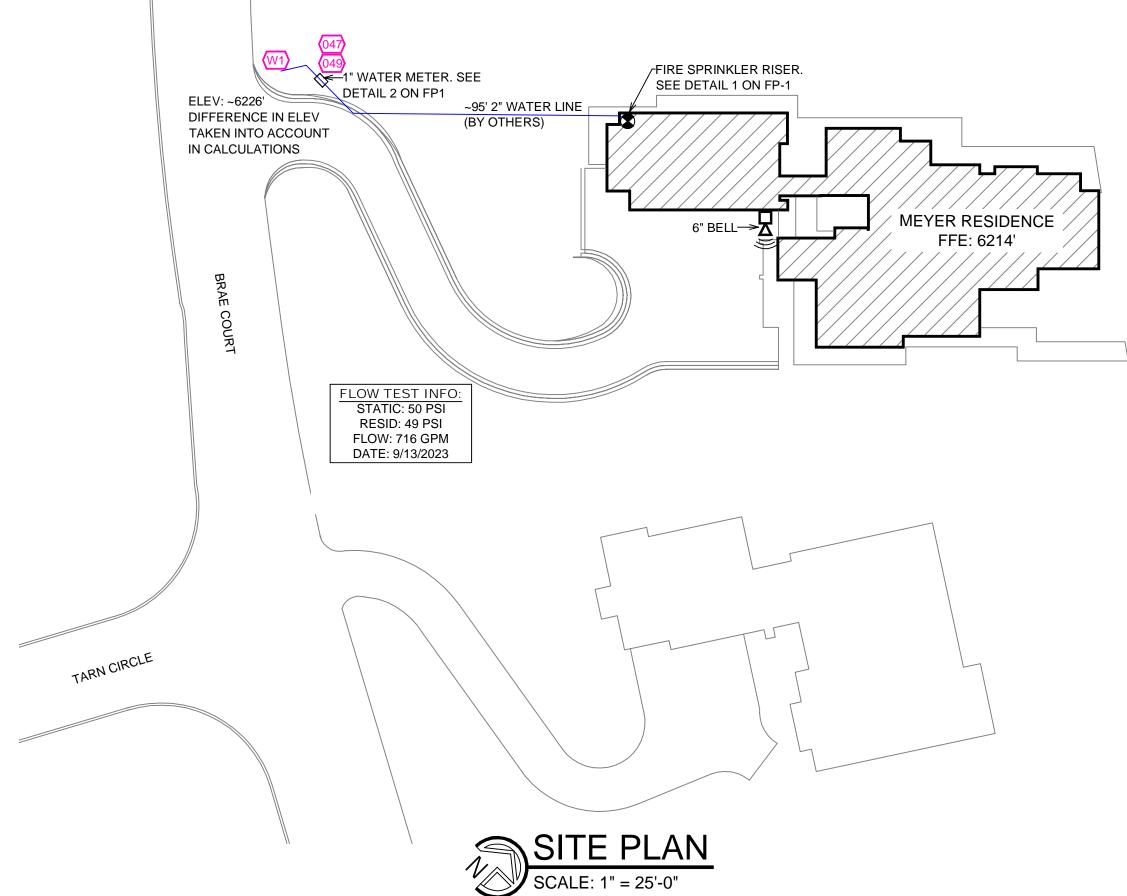

ATE		REVISIONS		DRAWN	CHECKE			
GENERAL CONTRACTOR:			AUTHORITY HAVING JURISDICTION TOWN OF TRUCKEE BUILDING DIVISION					
:			ADDRESS: 10183 TRUCKEE AIRPORT RD					
		CITY: TRUCK	EE, CA	96161				
			<del>-582-7</del>	7820				
CONTACT:			CONTACT:					
ECT:		FIELD INSF	FIELD INSPECTIONS:					
		1.	1.					
ADDRESS:			2.					
CITY:			3.					
PHONE:			4.					
	L CON	L CONTRACTOR:	L CONTRACTOR:  TOWN OF TR ADDRESS: 10 CITY: TRUCK PHONE: 530 CONTACT:  CCT: FIELD INSE 1. 2. 3.	L CONTRACTOR:  AUTHORITY HAVIN TOWN OF TRUCKEE  ADDRESS: 10183 TR CITY: TRUCKEE, CA PHONE: 530–582–7 CONTACT:  CCT:  FIELD INSPECTION 1. 2. 3.	L CONTRACTOR:  AUTHORITY HAVING JURIS TOWN OF TRUCKEE BUILDING ADDRESS: 10183 TRUCKEE AIF CITY: TRUCKEE, CA 96161 PHONE: 530-582-7820 CONTACT:  CCT: FIELD INSPECTIONS: 1. 2. 3.			

#### FIRE SPRINKLER NOTES:

- . THE PROPOSED FIRE SPRINKLER SYSTEM IS AN ANTI-FREEZE SYSTEM AND SHALL BE DESIGNED AND INSTALLED IN ACCORDANCE WITH NFPA 13D THIS SPRINKLER SYSTEM IS HYDRAULICALLY CALCULATED IN ACCORDANCE WITH NFPA 13D TO PROVIDE 0.05 GPM PER SQ. FT. OVER
- THE MOST REMOTE AREA. THE NUMBER OF DESIGN SPRINKLERS SHALL INCLUDE ALL SPRINKLERS
- WITHIN A COMPARTMENT UP TO A MAXIMUM OF 2 SPRINKLERS. 4. ALL SPRINKLER PIPING CONCEALED ABOVE CEILINGS SHALL BE CPVC
- PIPING UNLESS OTHERWISE NOTED.
- 5. ALL DIMENSIONS SHOWN ARE CENTER TO CENTER U.O.N. 6. ALL HANGERS SHALL BE INSTALLED IN ACCORDANCE WITH NFPA 13D AND/OR NFPA 13 REQUIREMENTS.
- . HOLES THROUGH SOLID STRUCTURAL MEMBERS SHALL BE PERMITTED TO SERVE AS HANGERS FOR THE SUPPORT OF SYSTEM PIPING.
- 8. ALL SYSTEM PIPING SHALL BE TESTED FOR LEAKAGE AT NORMAL SYSTEM OPERATING PRESSURE.
- THE OWNER SHALL BE RESPONSIBLE FOR MAINTAINING A MINIMUM TEMPERATURE OF 40° FAHRENHEIT TO PROTECT FROM FREEZING, THE SECTIONS OF THE SPRINKLER SYSTEM WHERE THERE IS NO ANTI-FREEZE IN THE PIPING (UPSTREAM OF THE RISER).

SPF	SPRINKLER HEAD LEGEND								
SYM	QTY	TYPE	MFG.	MODEL#	NPT	к	TEMP	FINISH	S.I.N.
•	49	CONCEALED	SENJU	RC-RES	1/2"	4.9	162	WHITE	SS8464
<b>(</b>	3	CONCEALED	SENJU	RC-RES	1/2"	4.9	205	WHITE	SS8464
<b>®</b>	8	SEMI-RECESS	SENJU	FR-RES	1/2"	4.9	205	WHITE	SS4451

### **60 TOTAL SPRINKLERS**

### FIRE SPRINKLER SYMBOLS

- AUTOMATIC SPRINKLER RISER \*13" ELEV. BELOW DECK OR TOS +12'-9" ELEV. ABOVE FINISHED FLOOR EARTHQUAKE BRACING 2-WAY & 4-WAY ── CHANGE ELEVATION UP
- FIPE HANGER & ── CHANGE ELEVATION DN TYPE DESIGNATION —

  → INSPECTORS TEST
- HYDRAULIC REF PT —₩ AUX DRAIN ← GRVD OR THRD CAP ⚠ REVISION NOTATION
- TYPICAL POINT OF 📤 LOCAL ALARM CONNECTION (POC)



PROJECT NAME: FIRE SPRINKLER PLANS FOR

# MEYER RESIDENCE

9259 BRAE CT TRUCKEE, CA 96161

STAMP:

FIRE SPRINKLER PLAN

SCALE: 1/8"=1'-0"	JOB NO.:
DRAWN BY:	DWG NO.:
BORN ON DATE: 12/4/2023	FP-1
	1 o- 2

