


	Nominal Pipe Size (in.)									
	3/4	1	11/4	11/2	2	21/2	3	4	6	8
Steel Pipe except threaded lightwall	N/A	12-0	12-0	15-0	15-0	15-0	15-0	15-0	15-0	15-0
Threaded lightwall steel pipe	N/A	12-0	12-0	15-0	15-0	15-0	15-0	N/A	N/A	N/A
Copper tube	8-0	8-0	10-0	10-0	12-0	12-0	12-0	15-0	15-0	15-0
CPVC	5-6	6-0	6-6	7-0	8-0	9-0	10-0	N/A	N/A	N/A

STRUCTURAL WOOD MEMBER

-1/4"x1 1/2" LAG SCREW

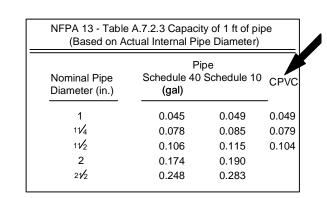

PIPE VOLUMES: (CPVC)
TOTAL PIPE FOOTAGE AND CAPACITY: 1" 469 (23.19 GAL) 1-1/4" 60 (4.76 GAL)
ADD 10% FOR DROPS AND PIPE SIZE DISCREPANCIES TOTAL VOLUME: ±30.75 GALLONS




NO SPRINKLERS REQUIRED IN: BATHROOMS 55 SQ.FT. OR LESS IN AREA PER NFPA 13D SECTION 8.6.2 CLOSETS 24 SQ.FT. OR LESS IN AREA PER NFPA 13D SECTION 8.6.3

PROJECT SQUARE FOOTAGES MAIN FLOOR = 7121 S.F.

SPRINKLER SPACING

- A SINGLE PENDENT SPRINKLER MAY BE SPACED AT A
- MAXIMUM OF 18'x18'(324SQ. FT.) OR UP TO 9' OFF A WALL. (MINIMUM 8'-0" BETWEEN SPRINKLERS)
- TWO OR MORE HEADS IN A COMPARTMENT SHALL BE SPACED AT A MAXIMUM OF 14'x14'(196 SQ. FT.) OR UP TO 7' OFF
- A WALL.(MINIMUM 8'-0" BETWEEN SPRINKLERS) SPRINKLERS SHALL BE MEASURED AT PERPENDICULAR ANGLES TO WALLS AND ALONG THE SLOPES OF CEILINGS.

THIS FIRE SPRINKLER SYSTEM UTILIZES THE NOBLE COMPANY FIREFIGHTER ELIMINATOR ANTI-FREEZE SOLUTION

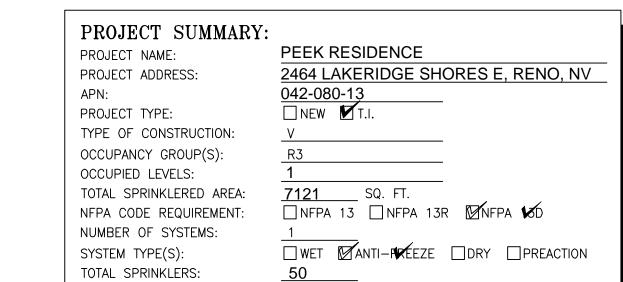

SPECIAL NOTES:

SEE FIRE SPRINKLER NOTES THIS SHEET

1" WATER-

METER

(EXISTING)

~110' 1-1/4" WATER LINE—


AUTHORITY HAVING JURISDICTION GENERAL CONTRACTOR: RENO FIRE DEPT ADDRESS: 495 E 4TH ST CITY: RENO, NV 89512 PHONE: 775-334-2300 CONTACT: CONTACT: FIELD INSPECTIONS:

REVISIONS

DRAWN CHECK


FIRE SPRINKLER NOTES:


- THE PROPOSED FIRE SPRINKLER SYSTEM IS AN ANTI-FREEZE SYSTEM AND SHALL BE DESIGNED AND INSTALLED IN ACCORDANCE WITH NFPA 13D . THIS SPRINKLER SYSTEM IS HYDRAULICALLY CALCULATED IN ACCORDANCE WITH NFPA 13D TO PROVIDE 0.05 GPM PER SQ. FT. OVER
- THE MOST REMOTE AREA. THE NUMBER OF DESIGN SPRINKLERS SHALL INCLUDE ALL SPRINKLERS WITHIN A COMPARTMENT UP TO A MAXIMUM OF 2 SPRINKLERS.
- 4. ALL SPRINKLER PIPING CONCEALED ABOVE CEILINGS SHALL BE CPVC PIPING UNLESS OTHERWISE NOTED.
- 5. ALL DIMENSIONS SHOWN ARE CENTER TO CENTER U.O.N. 6. ALL HANGERS SHALL BE INSTALLED IN ACCORDANCE WITH NFPA 13D AND/OR NFPA 13 REQUIREMENTS.
- 7. HOLES THROUGH SOLID STRUCTURAL MEMBERS SHALL BE PERMITTED TO SERVE AS HANGERS FOR THE SUPPORT OF SYSTEM PIPING.
- B. ALL SYSTEM PIPING SHALL BE TESTED FOR LEAKAGE AT NORMAL SYSTEM OPERATING PRESSURE.
- THE OWNER SHALL BE RESPONSIBLE FOR MAINTAINING A MINIMUM TEMPERATURE OF 40° FAHRENHEIT TO PROTECT FROM FREEZING, THE SECTIONS OF THE SPRINKLER SYSTEM WHERE THERE IS NO ANTI-FREEZE IN THE PIPING (UPSTREAM OF THE RISER).

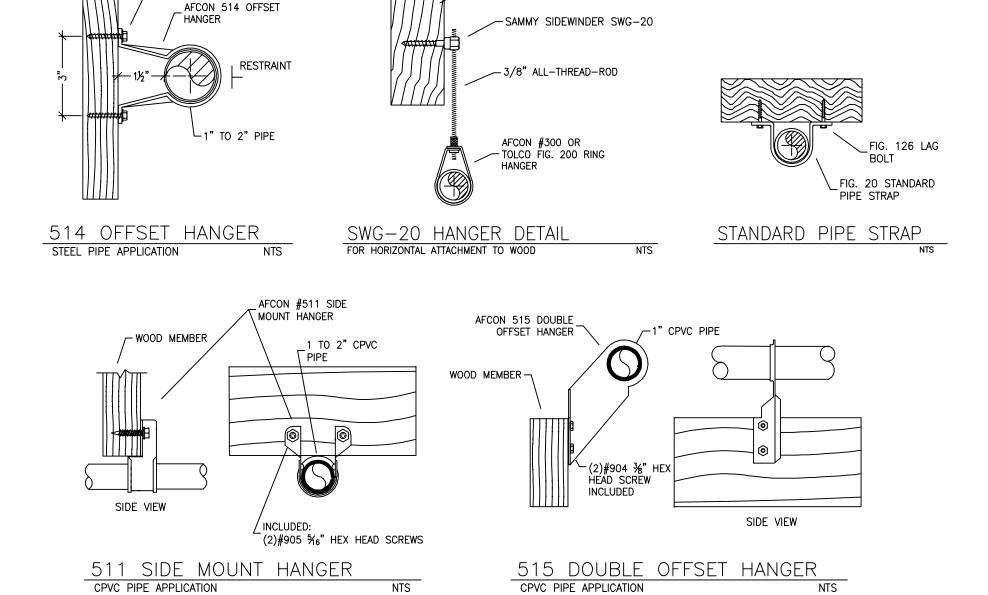

HANGER DETAILS

STRUCTURAL WOOD MEMBER

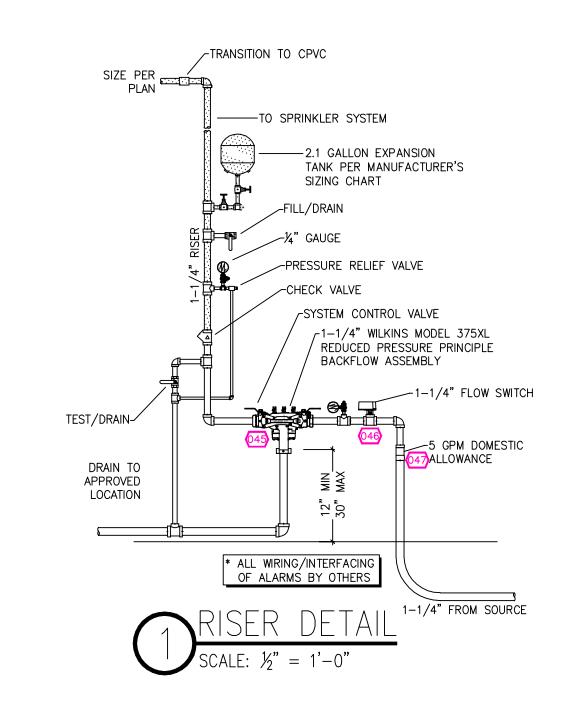

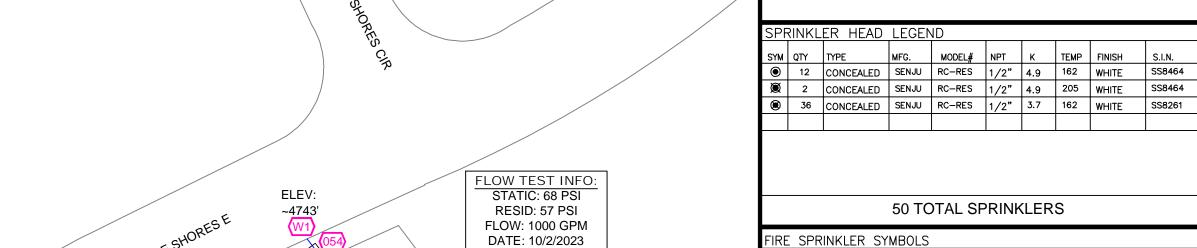

* FLOW TEST INFORMATION

PROVIDED BY TRUCKEE

MEADOWS WATER AUTHORITY

FIRE SPRINKLER RISER.

SEE DETAIL 1 ON FP-1

+12'-9" ELEV. ABOVE FINISHED FLOOR EARTHQUAKE BRACING ──── CHANGE ELEVATION UP 2-WAY & 4-WAY

PIPE HANGER &
TYPE DESIGNATION

—

→


INSPECTORS TEST —Ø AUX DRAIN GRVD OR THRD CAP


GRVD COUPLING

A REVISION NOTATION TYPICAL POINT OF

CONNECTION (POC)

──── CHANGE ELEVATION DN

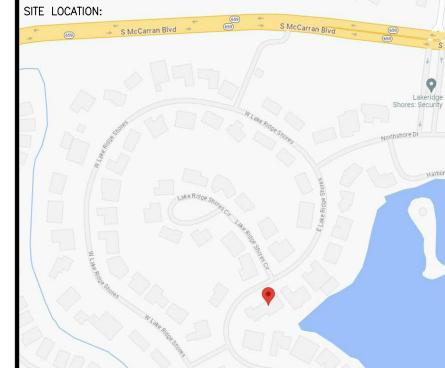

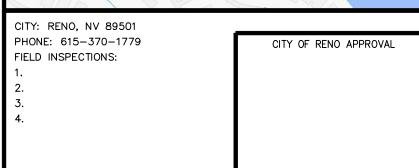

TOP OF ROOF 19' - 0"

CITY OF RENO MULTI-DIVISIONAL APPROVAL BOX

PROJECT NAME: FIRE SPRINKLER PLANS FOR PEEK RESIDENCE 2464 LAKE RIDGE SHORES E RENO, NV 88519


DRAWING TITLE:

FIRE SPRINKLER PLAN

CALE: 1/8"=1'-0" FP-1 BORN ON DATE: 10/13/2023 SHEET 1 OF 2

BUILDING SECTION

SCALE: $\frac{1}{8}$ " = 1'-0"

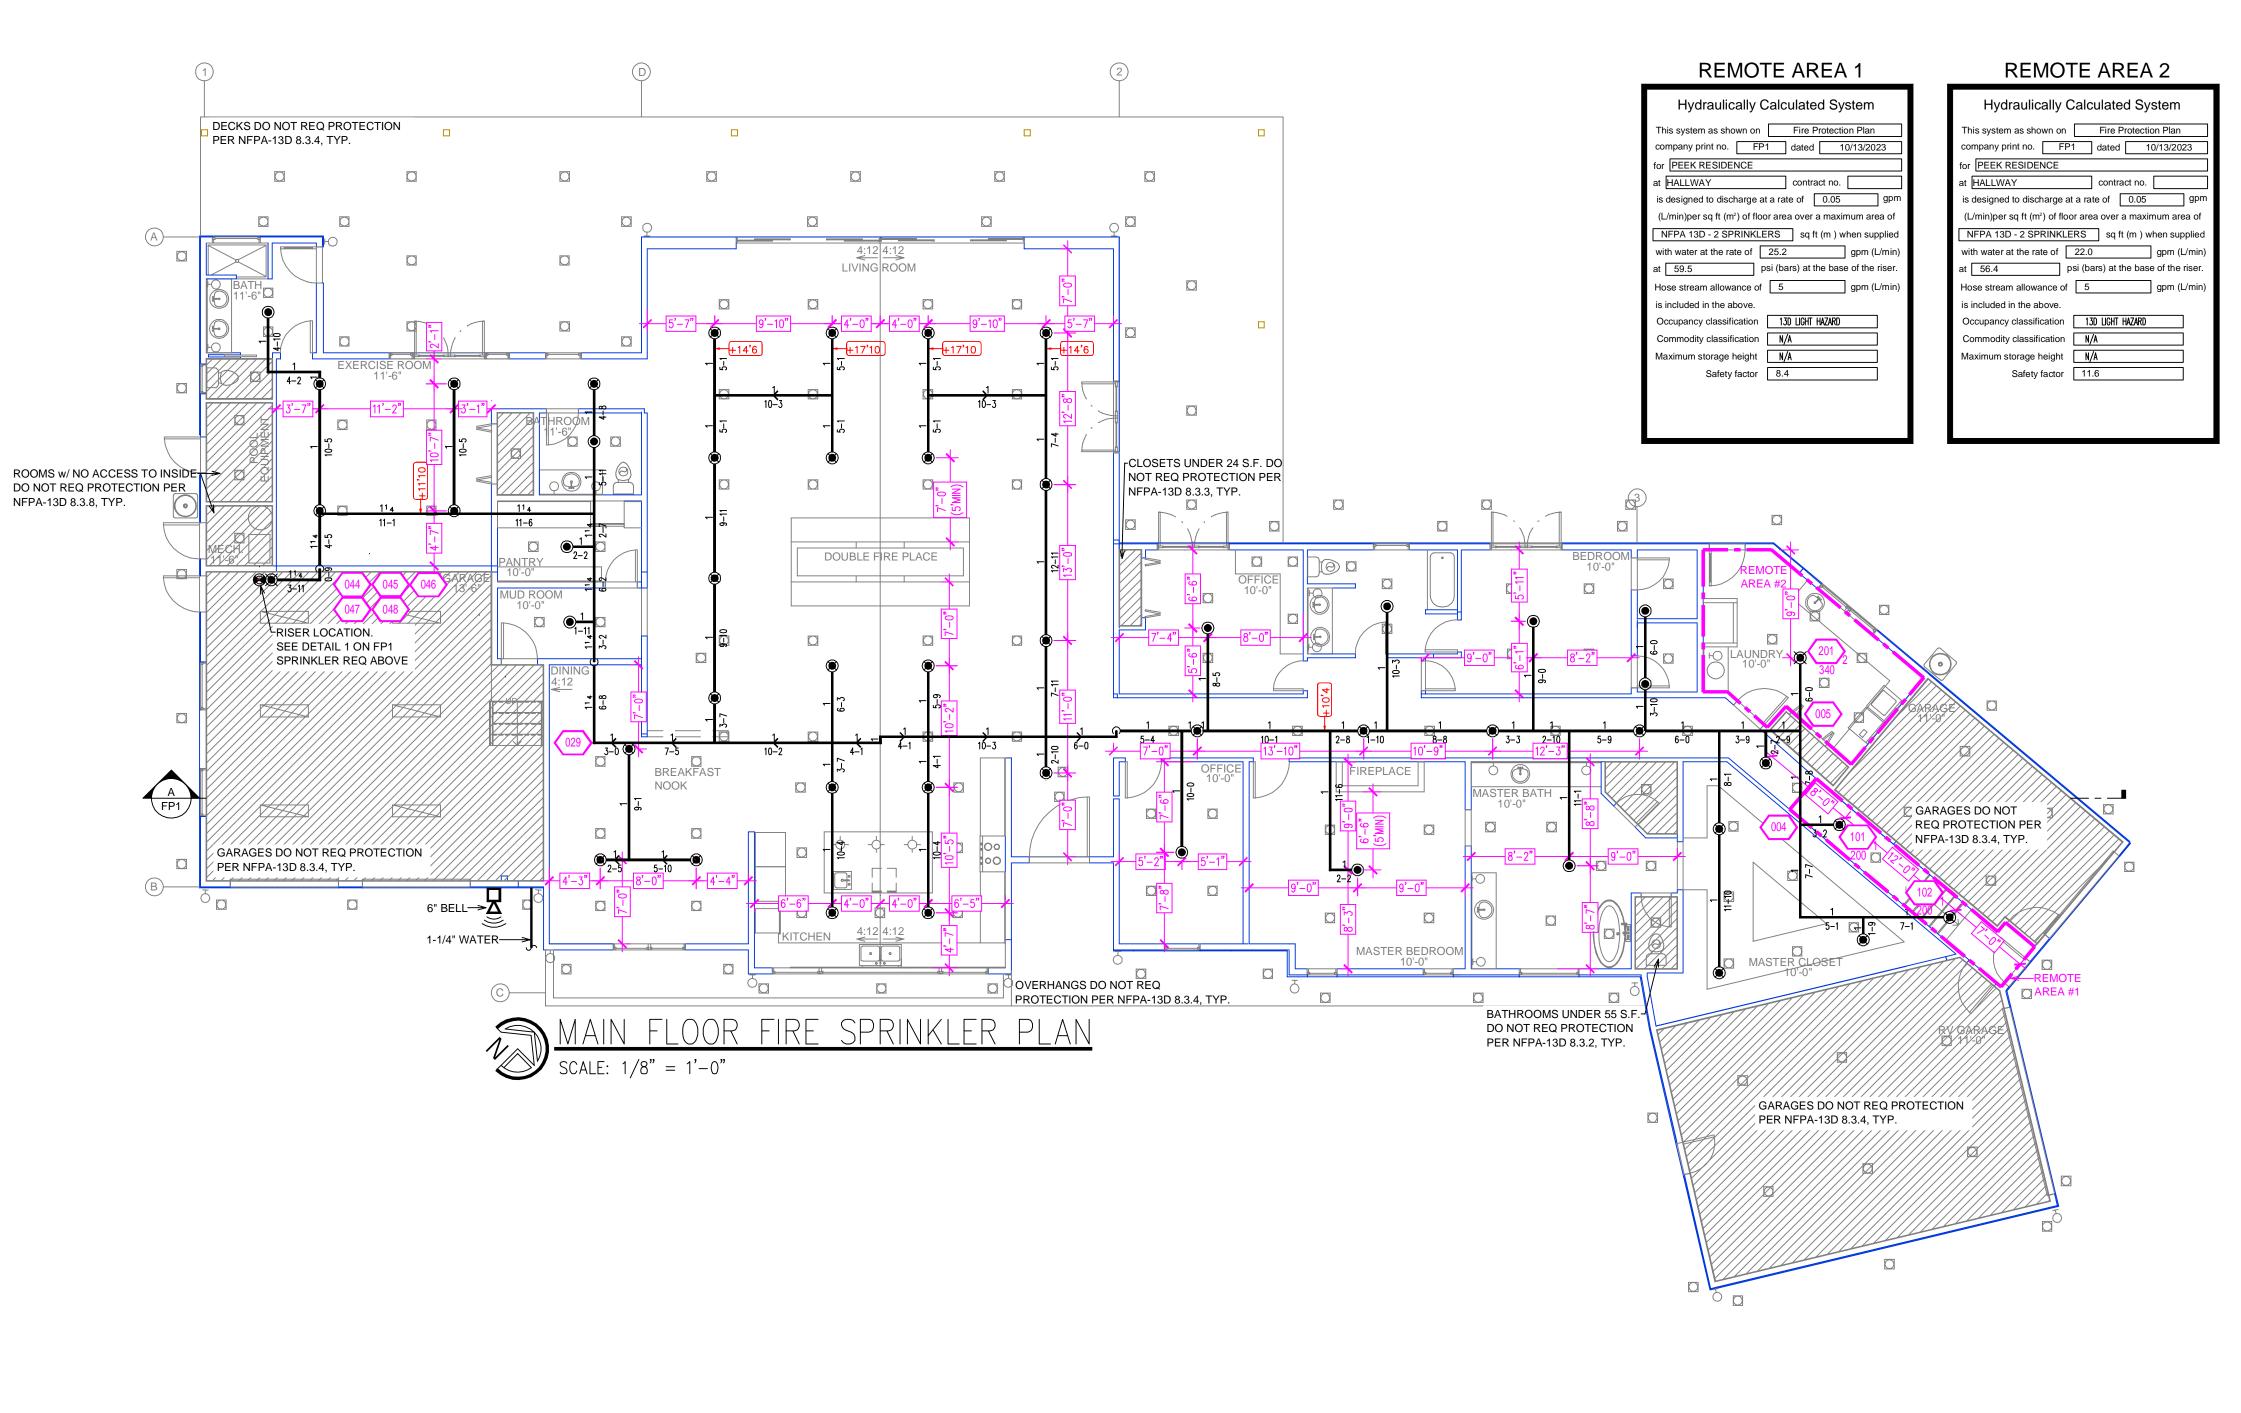

REVISIONS DRAWN CHECKE AUTHORITY HAVING JURISDICTION RENO FIRE DEPT ADDRESS: 495 E 4TH ST CITY: RENO, NV 89512 PHONE: 775-334-2300 CONTACT: CONTACT: FIELD INSPECTIONS:

FIRE SPRINKLER NOTES:

- THE PROPOSED FIRE SPRINKLER SYSTEM IS AN ANTI-FREEZE SYSTEM AND SHALL BE DESIGNED AND INSTALLED IN ACCORDANCE WITH NFPA 13D THIS SPRINKLER SYSTEM IS HYDRAULICALLY CALCULATED IN ACCORDANCE WITH NFPA 13D TO PROVIDE 0.05 GPM PER SQ. FT. OVER
- THE MOST REMOTE AREA. THE NUMBER OF DESIGN SPRINKLERS SHALL INCLUDE ALL SPRINKLERS WITHIN A COMPARTMENT UP TO A MAXIMUM OF 2 SPRINKLERS.
- 4. ALL SPRINKLER PIPING CONCEALED ABOVE CEILINGS SHALL BE CPVC PIPING UNLESS OTHERWISE NOTED.
- 5. ALL DIMENSIONS SHOWN ARE CENTER TO CENTER U.O.N. 3. ALL HANGERS SHALL BE INSTALLED IN ACCORDANCE WITH NFPA 13D AND/OR NFPA 13 REQUIREMENTS.
- . HOLES THROUGH SOLID STRUCTURAL MEMBERS SHALL BE PERMITTED TO SERVE AS HANGERS FOR THE SUPPORT OF SYSTEM PIPING.
- 3. ALL SYSTEM PIPING SHALL BE TESTED FOR LEAKAGE AT NORMAL SYSTEM OPERATING PRESSURE.
- THE OWNER SHALL BE RESPONSIBLE FOR MAINTAINING A MINIMUM TEMPERATURE OF 40° FAHRENHEIT TO PROTECT FROM FREEZING, THE SECTIONS OF THE SPRINKLER SYSTEM WHERE THERE IS NO ANTI-FREEZE IN THE PIPING (UPSTREAM OF THE RISER).


	SPF	SPRINKLER HEAD LEGEND								
	SYM	QTY	TYPE	MFG.	MODEL#	NPT	к	TEMP	FINISH	S.I.N.
	•	12	CONCEALED	SENJU	RC-RES	1/2"	4.9	162	WHITE	SS8464
I	(2	CONCEALED	SENJU	RC-RES	1/2"	4.9	205	WHITE	SS8464
ı	•	36	CONCEALED	SENJU	RC-RES	1/2"	3.7	162	WHITE	SS8261

50 TOTAL SPRINKLERS

FIRE SPRINKLER SYMBOLS

- ♦ AUTOMATIC SPRINKLER RISER *13" ELEV. BELOW DECK OR TOS EARTHQUAKE BRACING
 2-WAY & 4-WAY +12'-9" ELEV. ABOVE FINISHED FLOOR ── CHANGE ELEVATION UP
- PIPE HANGER &
 TYPE DESIGNATION ── CHANGE ELEVATION DN
- inspectors test HYDRAULIC REF PT —Ø AUX DRAIN ← GRVD OR THRD CAP ⚠ REVISION NOTATION
- ____ GRVD COUPLING TYPICAL POINT OF

🔔 LOCAL ALARM CONNECTION (POC)

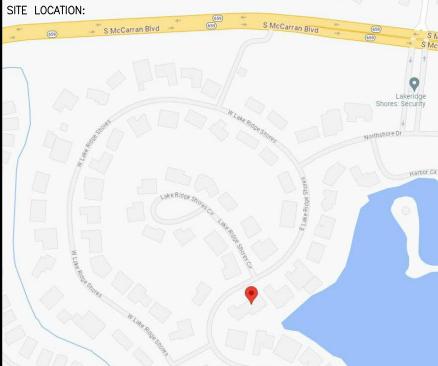

CITY: RENO, NV 89501 PHONE: 615-370-1779 CITY OF RENO APPROVAL FIELD INSPECTIONS:

CITY OF RENO MULTI-DIVISIONAL APPROVAL BOX

PROJECT NAME:

FIRE SPRINKLER PLANS FOR PEEK RESIDENCE 2464 LAKE RIDGE SHORES E RENO, NV 88519

DRAWING TITLE:

FIRE SPRINKLER PLAN

SHEET <u>2</u> OF <u>2</u>

SCALE: 1/8"=1'-0" FP-2 BORN ON DATE: 10/13/2023