





SECTION -C-SCALE= 1/4" : 1'-0"

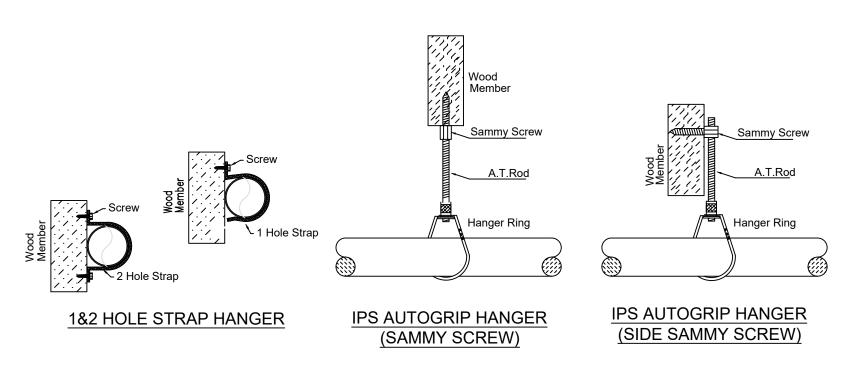


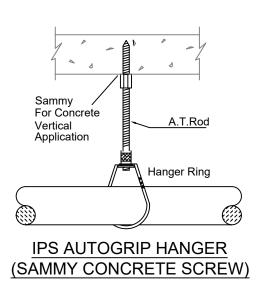

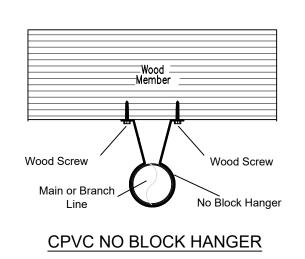


HANGER DETAILS

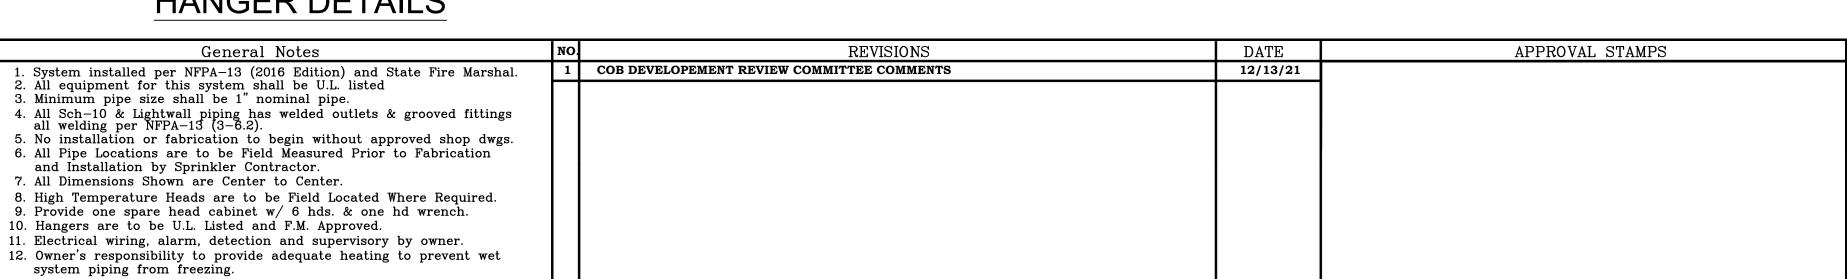


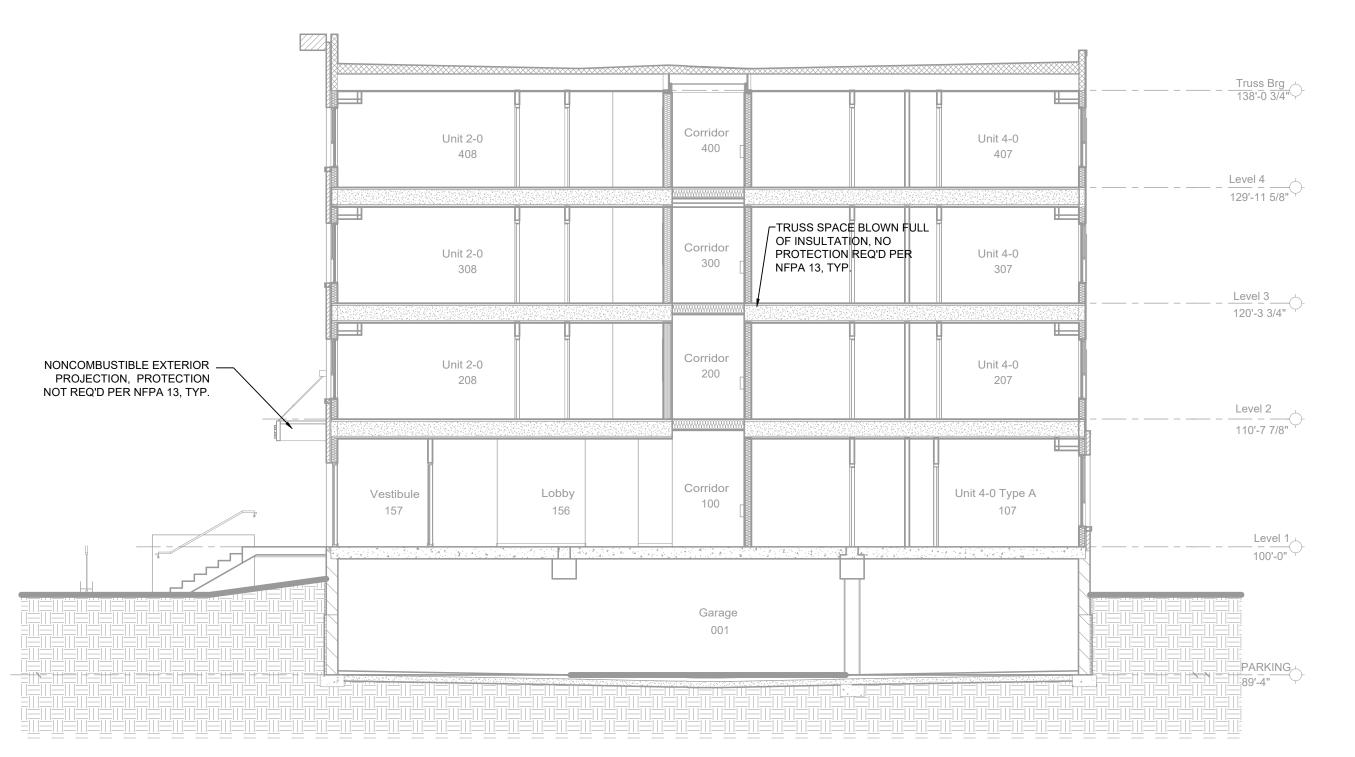

SECTION -A-SCALE= 1/8": 1'-0"

3/,"	1"	1 1/4"		2"	,	3"	4"	6"	8"		
NA	12-0	12-0	15-0	15-0	15-0	15-0	15-0	15-0	15-0		
NA	12-0	12-0	12-0	12-0	NA	NA	NA	NA	NA		
5-6	6-0	6-6	7-0	8-0	9-0	10-0	NA	NA	NA		
	3/4" NA NA	3/ ₄ " 1" NA 12-0 NA 12-0	¾" 1" 1¼" NA 12-0 12-0 NA 12-0 12-0	NA 12-0 12-0 12-0 12-0	NOMINAL PI 3/4" 1" 1 1/4" 1 1/2" 2" NA 12-0 12-0 15-0 15-0 NA 12-0 12-0 12-0 12-0	3/4" 1" 1 1/4" 1 1/2" 2" 2 1/2" NA 12-0 12-0 15-0 15-0 15-0 NA 12-0 12-0 12-0 NA	NOMINAL PIPE SIZE (IN.) 3/4" 1" 1 1/4" 1 1/2" 2" 2 1/2" 3" NA 12-0 12-0 15-0 15-0 15-0 NA 12-0 12-0 12-0 NA NA	NOMINAL PIPE SIZE (IN.) 3/4" 1" 1 1/4" 1 1/2" 2" 2 1/2" 3" 4" NA 12-0 12-0 15-0 15-0 15-0 15-0 NA 12-0 12-0 12-0 NA NA NA NA	NOMINAL PIPE SIZE (IN.) 3/4" 1" 1 1/4" 1 1/2" 2" 2 1/2" 3" 4" 6" NA 12-0 12-0 15-0 15-0 15-0 15-0 15-0 NA 12-0 12-0 12-0 NA NA NA NA NA NA NA N		

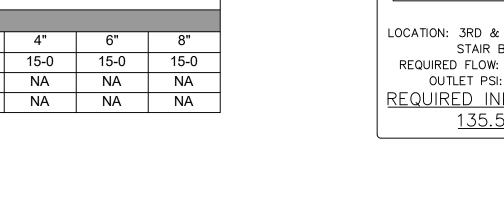

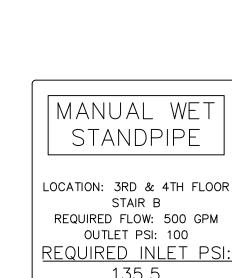

SYM	CNT	POSITION	FINISH	TEMP	K	NPT	SIN	MFG.	MODEL#	ESCUTCHEON	SPACING
lacksquare	414	PENDENT	WHITE	155	4.90	1/2"	TY2234	TYCO	LFII	SEMI-RECESS	18X18 UNO
◁	30	SIDEWALL	WHITE	200	5.60	1/2"	TY3331	TYCO	TY-FRB	SEMI-RECESS	10X10
◀	145	SIDEWALL	WHITE	155	4.40	1/2"	TY2334	TYCO	LFII	SEMI-RECESS	16X16
√ 155°	17	SIDEWALL	WHITE	155	5.60	1/2"	TY3331	TYCO	TY-FRB	SEMI-RECESS	14X14
⊲ sw20	5	SIDEWALL	WHITE	200	11.20	3/4"	TY5332	TYCO	ELOSW20	SEMI-RECESS	16X16 UNO
4	40	SIDEWALL	WHITE	155	5.60	1/2"	RA1564	RELIABLE	DH56	SEMI-RECESS	28X8
2 00°	91	PENDENT	WHITE	200	5.60	1/2"	TY323	TYCO	TY-FRB	SEMI-RECESS	130 S.F.
3	30	PENDENT	WHITE	155	5.60	1/2"	TY323	TYCO	TY-FRB	SEMI-RECESS	15X15
<u> </u>	10	PENDENT	WHITE	155	3.00	1/2"	TY1234	TYCO	LFII	SEMI-RECESS	14X14
$\overline{\mathbb{X}}$	65	UPRIGHT	BRASS	200	14.00	3/4"	TY6137	TYCO	EC-14	N/A	SEE PLAN
$\overline{\mathbb{C}}$	12	UPRIGHT	BRASS	200	5.60	1/2"	TY313	TYCO	TY-FRB	N/A	130 S.F.
286°	3	UPRIGHT	BRASS	286	5.60	1/2"	TY313	TYCO	TY-FRB	N/A	130 S.F.
<u> </u>											

PIPE LEGEND

BLACK STEEL SPRINKLER PIPING

CPVC BLAZEMASTER SPRINKLER PIPING

GENERAL NOTES

1.3. SPRINKLERED AREAS (APPROXIMATE - SEE ARCHITECTURAL PLANS FOR ACTUAL)

SPRINKLER SYSTEM DESIGNED AND INSTALLED PER NFPA-13, NFPA-14 (2016)

2.1. 1" BRANCH LINES TO BE BLAZEMASTER CPVC PIPING WITH CEMENTED FITTINGS

3.2. UNITS, OFFICES, MAIL ROOM, & SIMILAR AREAS ARE DESIGNED TO LIGHT HAZARD.

2.2. 1¼" THROUGH 2" MAIN & BRANCH LINES TO BE BLAZEMASTER CPVC PIPING WITH CEMENTED FITTINGS 2.3. 1" BRANCH LINES TO BE BLK LIGHTWALL THREADED PIPING WITH THREADED FITTINGS

3.3. REMOTE AREA REDUCTIONS HAVE BEEN TAKEN WHERE APPLICABLE PER NFPA 13 SEC. 11.2.3.2.3

(OH1) ROOM HAZARD CLASSIFICATION (ALL ROOMS ARE CONSIDERED LIGHT HAZARD UNLESS NOTED)

2.4. 1½" THROUGH 6" MAIN & BRANCH LINES TO BE BLK LIGHTWALL PIPING WITH SHORT RADIUS GROOVED FITTINGS

3.1. PARKING LEVEL, RISER ROOM, TRASH ROOMS, STORAGE ROOMS, ELECTRICAL ROOMS, & SIMILAR AREAS ARE

4.2. HANGERS TO BE INSTALLED IN ACCORDANCE WITH NFPA 13 (2016) - SEE PLAN FOR HANGING REQUIREMENTS

TO INSTALL NEW SPRINKLER SYSTEM IN THE NEW OLD CEDAR APARTMENT BUIDLING AS SHOW

ON THESE DRAWINGS. THEY SYSTEM WILL CONSIST OF 1 WET ZONE FOR THE PARKING GARAGE. LEVELS 1 THRU 4 ARE TO BE ZONED PER FLOOR OFF OF THE COMBONATION STANDPIPE WITH LEVELS 3 & 4 BEING COMBINED

6.2. ALL AREAS OF THE BUILDING TO BE INSTALLED AND COVERED IN ACCORDANCE WITH THE LOCAL AUTHORITY

1. MINNESOTA STATE BUIDLING CODE (2020)

PARKING = 19,384 S.F. (ZONE 1) LEVEL 1 = 19,132 S.F. (ZONE 2) LEVEL 2 = 19,132 S.F. (ZONE 3) LEVEL 3 = 19,132 S.F. (ZONE 4) LEVEL 4 = 19,132 S.F. (ZONE 4)

TOTAL = 95,912 S.F.

DESIGNED TO ORDINARY HAZARD GROUP 1.

4.1. ALL MATERIAL TO BE NEW AND MEET U.L. STANDARDS

(F1) HYDRAULIC CALCULATION JUNCTION POINT

HAVING JURISDICTION AND PER NFPA 13 (2016)

1.1. OCCUPANCY: TYPE R-2, S-21.2. TYPE OF CONSTRUCTION:VA

1.4. INSTALLATION STANDARDS:

2. SPRINKLER PIPE TYPES:

5. SYMBOLS USED ON DRAWINGS:

8'-0"CEILING HEIGHT

SCOPE OF WORK:

871 TOTAL HEADS

+9'6" PIPE ELEVATION A.F.F


*12" PIPE ELEVATION BELOW B.O.D

SPRINKLER HEAD LEGEND


| 155 | 4.00 | 1/2" | VK486 | VIKING | FREEDOM | SEMI-RECESS |

MIN 5/8" AND 1-1/4" DEPTH HILTI FS-1 INTUMESCENT FIRE CAULKING MIN 5/8" DEPTH HILTI FS-1 INTUMESCENT FIRE CAULKING GYPSUM WALL ASSEMBLY MIN 5/8" DEPTH HILTI FS-1 INTUMESCENT GYPSUM WALL ASSEMBLY FIRE CAULKING CPVC PIPE STEEL PIPE MIN. 1/2" BEAD HILTI FS-1 INTUMESCENT FIRE CAULK MIN. 1/2" BEAD HILTI FS-1 INTUMESCENT FIRE CAULK MIN. 1/2" BEAD HILTI FS-1 INTUMESCENT FIRE CAULK AT POINT OF CONTACT AT POINT OF CONTACT AT POINT OF CONTACT FIRE RATED CONCRETE PENETRATION FIRE RATED GYPSUM PENETRATION FIRE RATED GYPSUM WALL ASSEMBLY W-J-1067 ASSEMBLY W-L-1054 PENETRATION ASSEMBLY W-L-2377 Use Hilti FS-1 MAX Fire Stop Use Hilti FS-1 MAX Fire Stop Use Hilti FS-1 MAX Fire Stop

FIRESTOPPING DETAILS

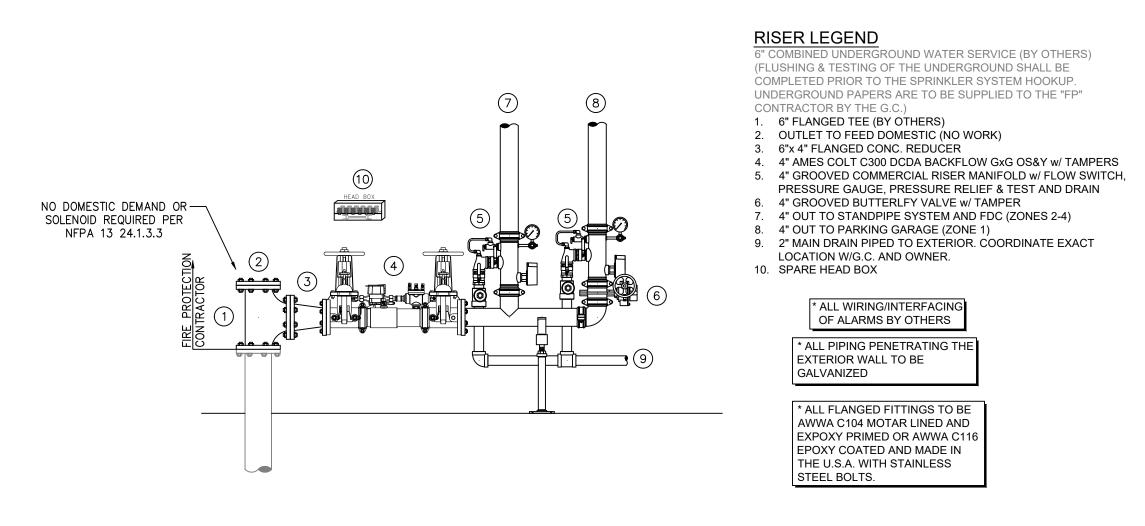



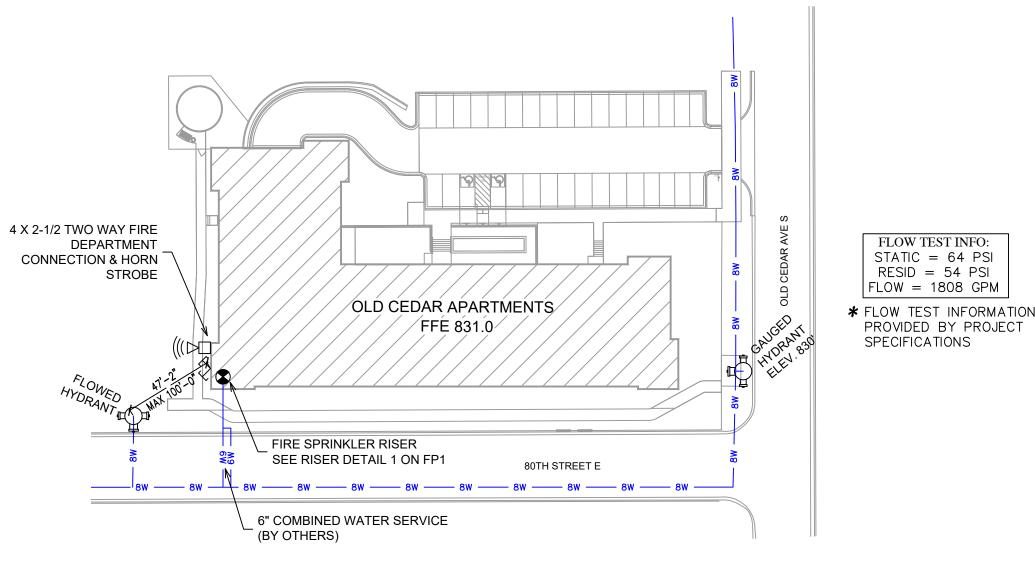



OLD CEDAR
APARTMENTS
8012 OLD CEDAR AVE S
BLOOMINGTON, MN 55425

Contract No.
C21-81


Drawing Date: 10/26/21

 Scale:
 1/8" = 1'-0"

 Drawn By:
 JH

 Approval By:
 STATE FIRE MARSHAL DIV.

 FP SHEET NO.
 1 of 6

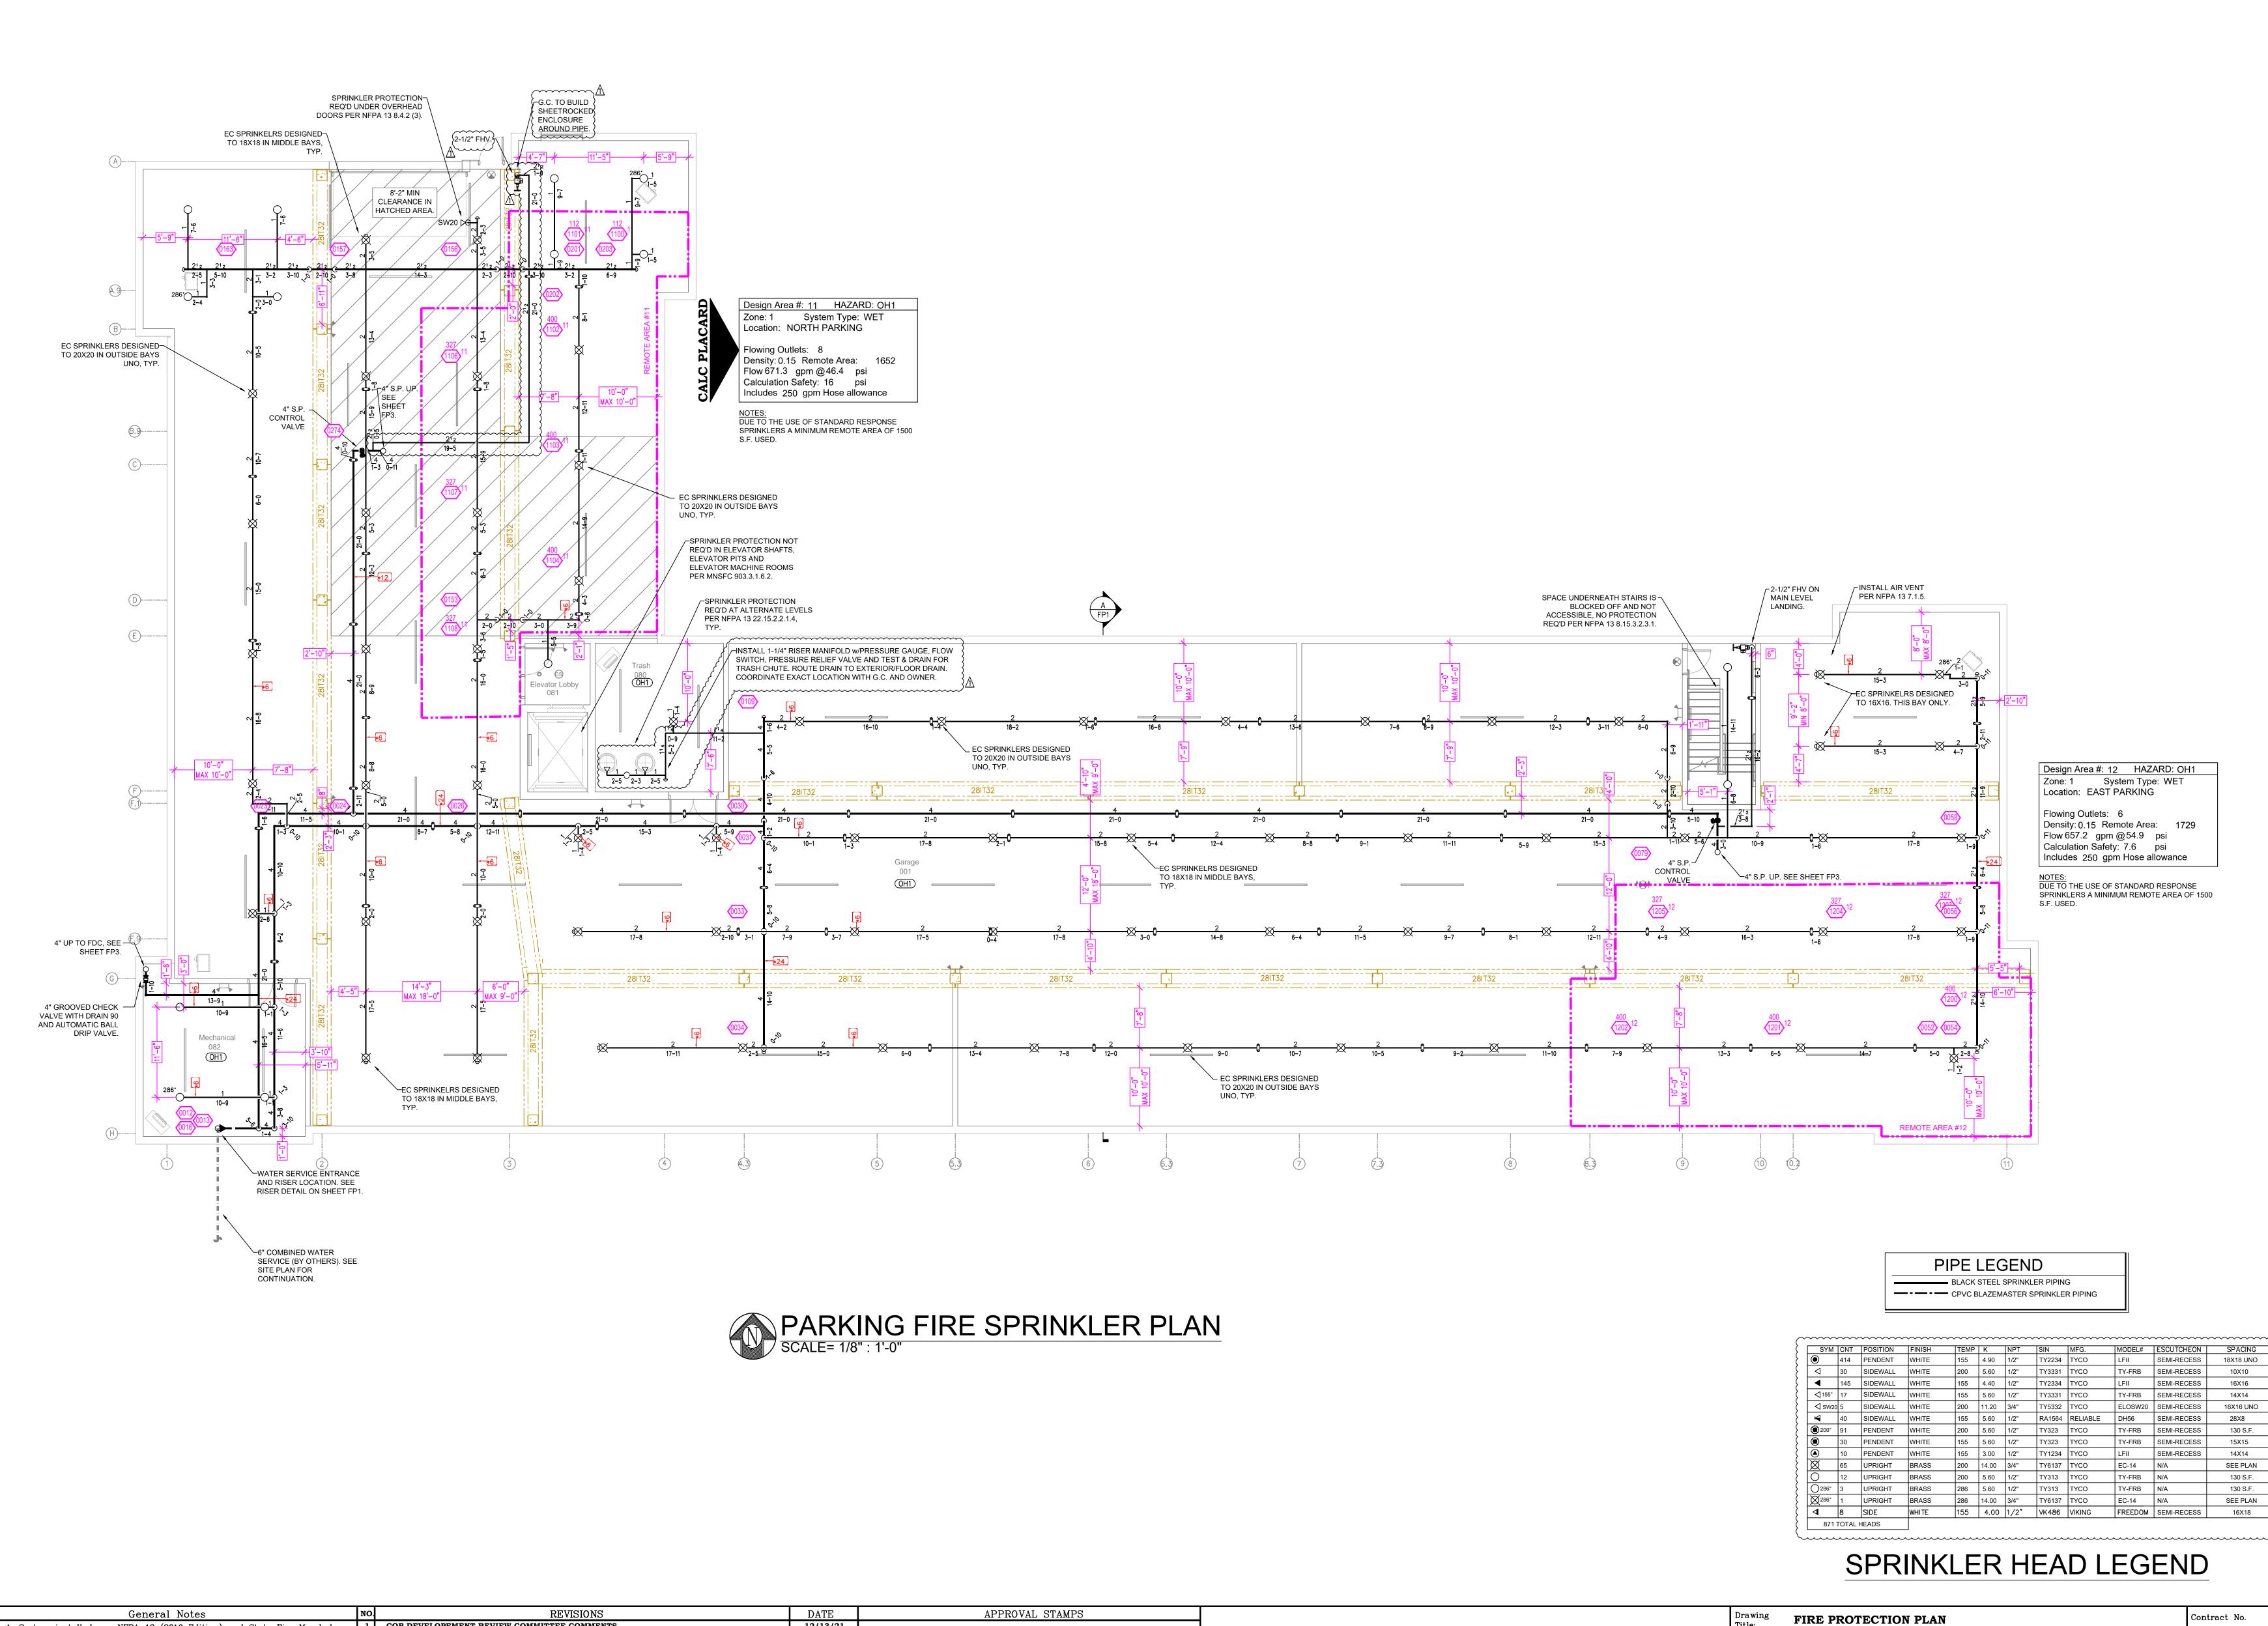

1 COB DEVELOPEMENT REVIEW COMMITTEE COMMENTS 12/13/21 1. System installed per NFPA-13 (2016 Edition) and State Fire Marshal. 2. All equipment for this system shall be U.L. listed
3. Minimum pipe size shall be 1" nominal pipe. 4. All Sch-10 & Lightwall piping has welded outlets & grooved fittings all welding per NFPA-13 (3-6.2).
5. No installation or fabrication to begin without approved shop dwgs. 6. All Pipe Locations are to be Field Measured Prior to Fabrication

OLD CEDAR

C21-81 Drawing Date: 10/26/21 1/8" = 1'-0" Drawn By: STATE FIRE MARSHAL DIV. FP SHEET NO. 2 of 6

APARTMENTS 8012 OLD CEDAR AVE S BLOOMINGTON, MN 55425

	W	S		➤ E	
2'	4' 6'	8'	10' 12'	14'	16' 18'


and Installation by Sprinkler Contractor. 7. All Dimensions Shown are Center to Center.

10. Hangers are to be U.L. Listed and F.M. Approved.

8. High Temperature Heads are to be Field Located Where Required.
9. Provide one spare head cabinet w/ 6 hds. & one hd wrench.

12. Owner's responsibility to provide adequate heating to prevent wet system piping from freezing.

11. Electrical wiring, alarm, detection and supervisory by owner.

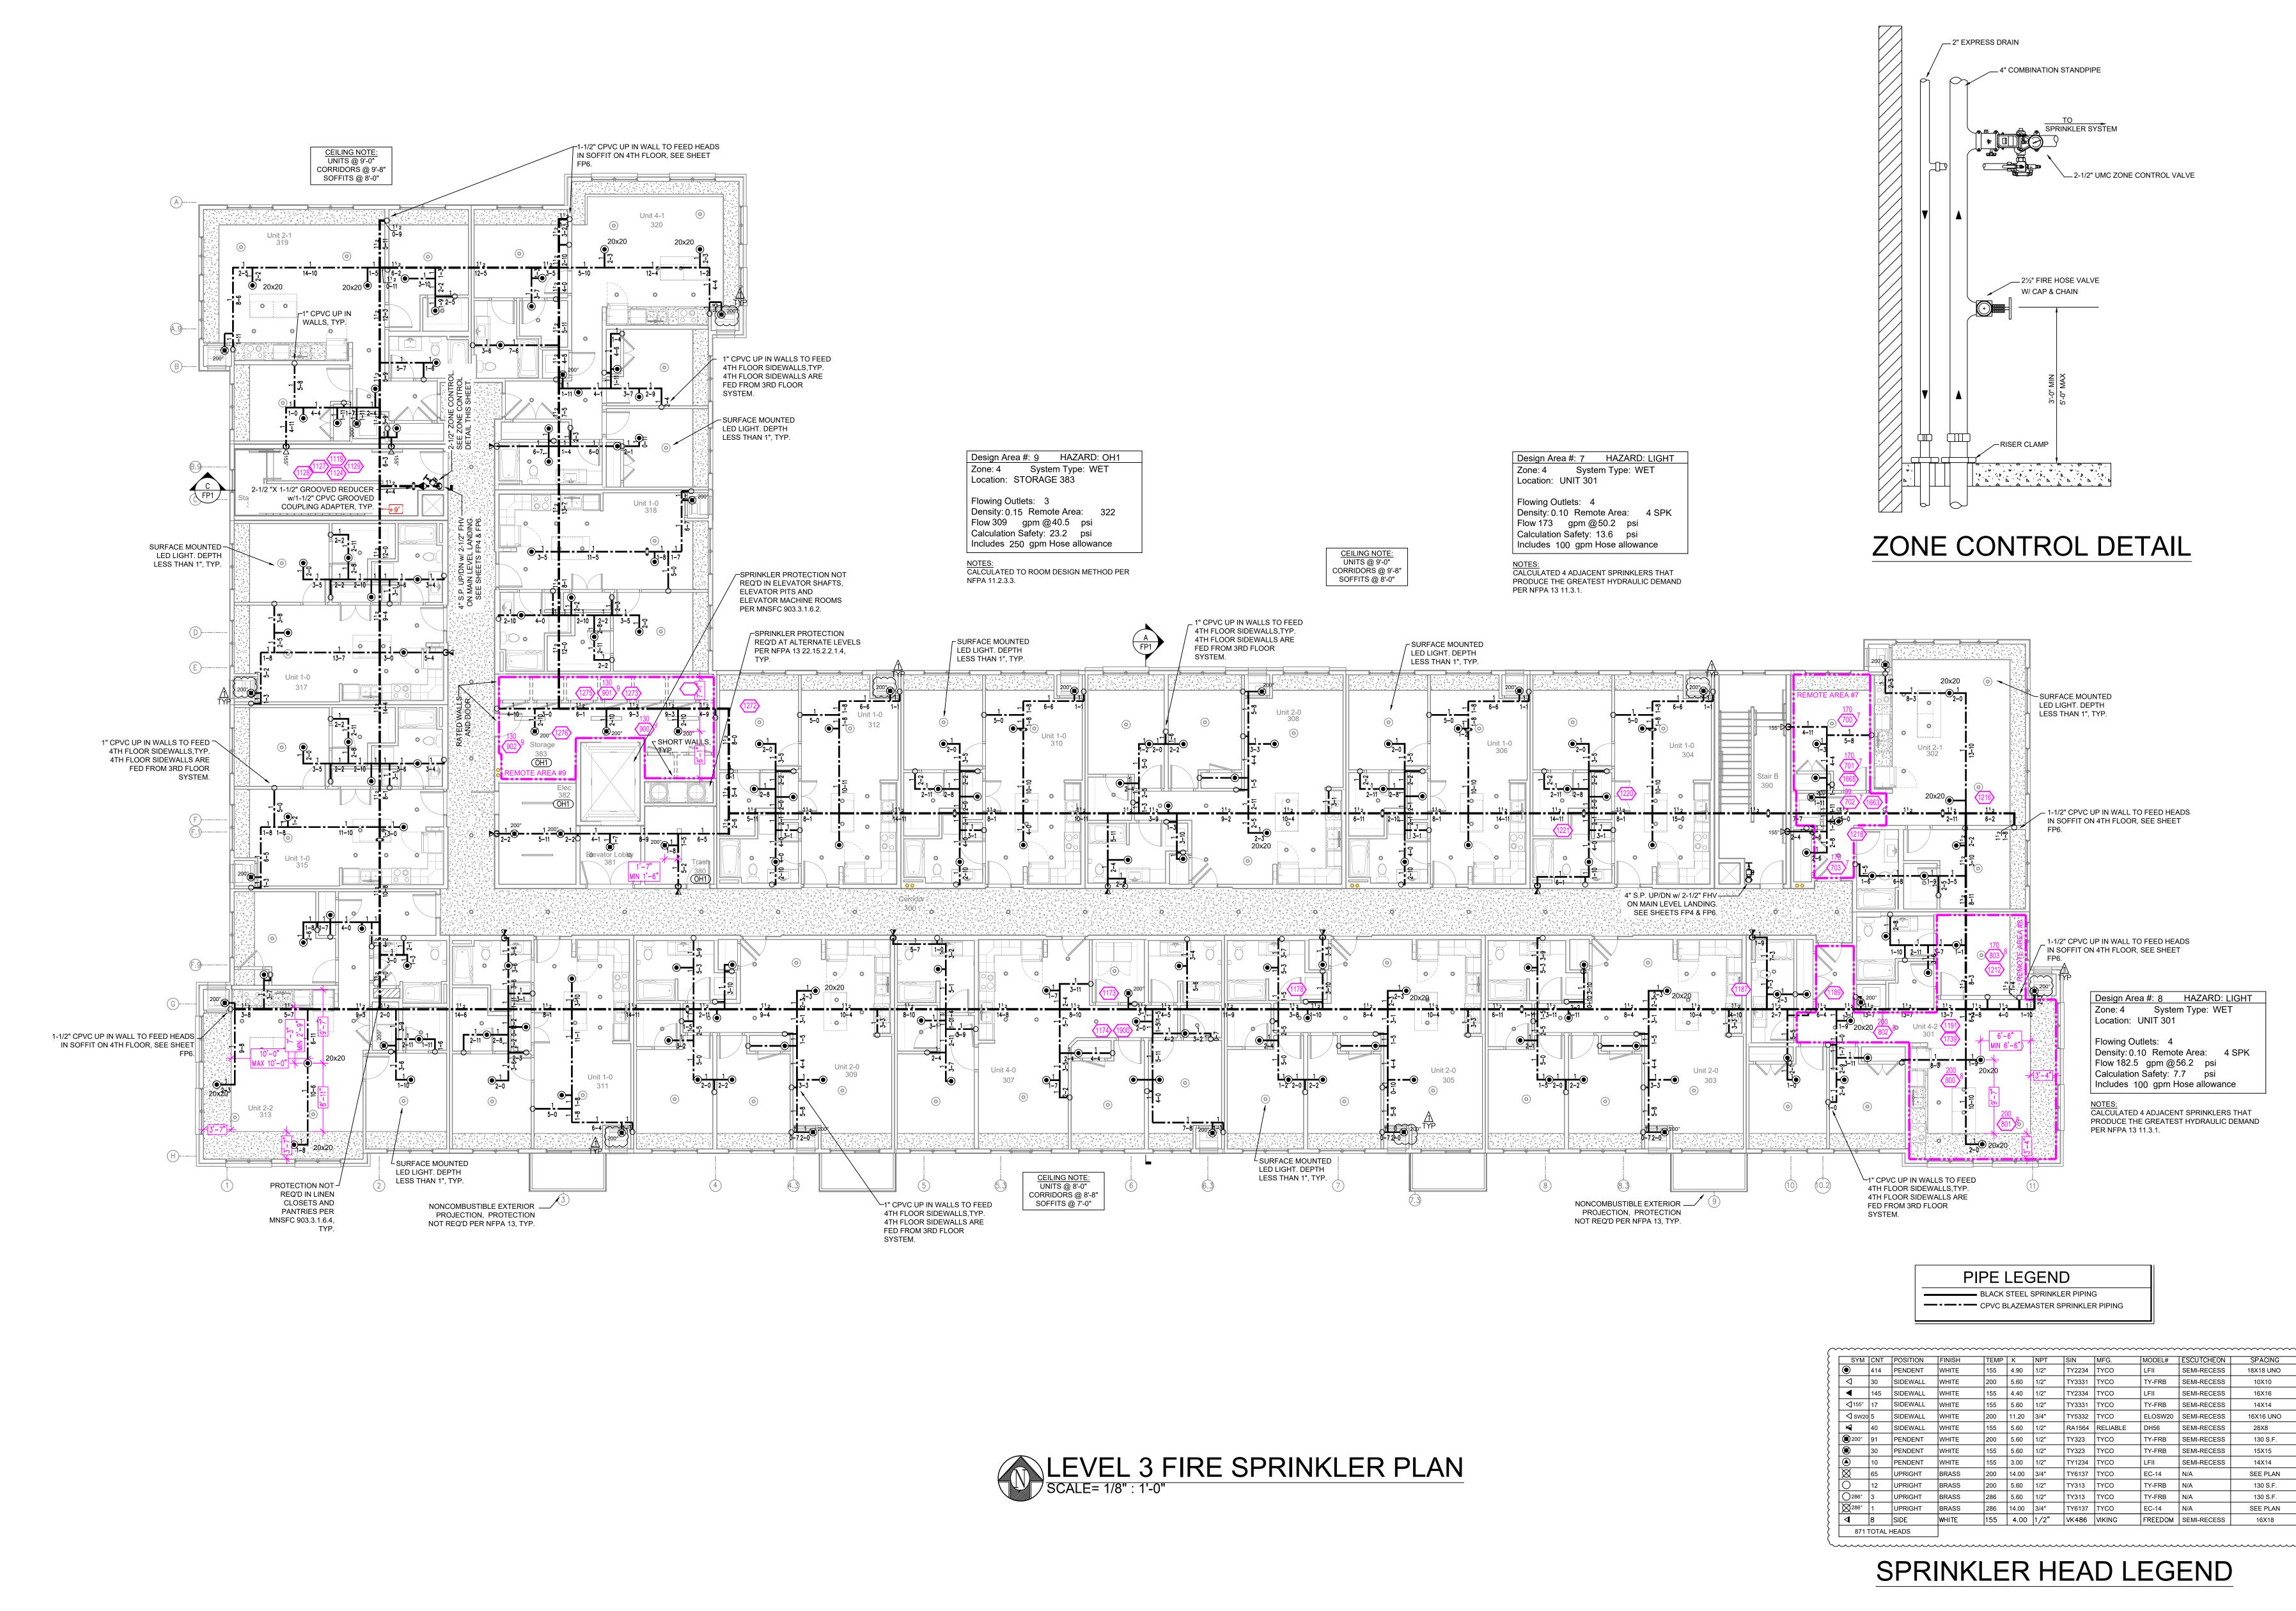

rawing the:

FIRE PROTECTION PLAN

OT DOC DOC DOC

BLOOMINGTON, MN 55425

 C21-81

 Drawing Date:
 10/26/21

 Scale:
 1/8" = 1'-0"

 Drawn By:
 JH

 Approval By:
 STATE FIRE MARSHAL DIV.

 FP SHEET NO.
 5 of 6

General Notes

No. REVISIONS

1. System installed per NFPA-13 (2016 Edition) and State Fire Marshal.
2. All equipment for this system shall be U.L. listed
3. Minimum pipe size shall be 1" nominal pipe.
4. All Sch-10 & Lightwall piping has welded outlets & grooved fittings all welding per NFPA-13 (3-6.2).
5. No installation or fabrication to begin without approved shop dwgs.
6. All Pipe Locations are to be Field Measured Prior to Fabrication and Installation by Sprinkler Contractor.
7. All Dimensions Shown are Center to Center.
8. High Temperature Heads are to be Field Located Where Required.
9. Provide one spare head cabinet w/ 6 hds. & one hd wrench.
10. Hangers are to be U.L. Listed and F.M. Approved.
11. Electrical wiring, alarm, detection and supervisory by owner.

12. Owner's responsibility to provide adequate heating to prevent wet

system piping from freezing.

OLD CEDAR APARTMENTS 8012 OLD CEDAR AVE S

