

BUILDING NOTES:


- 1. FIRE PUMP HOUSE TO BE ALL METAL CONSTRUCTION.
- 2. BRICK TO BE TABS II BRICK WALL SYSTEM WITH 4" X 12" DIMENSIONS. PAINTING CONTRACTOR TO PAINT BRICK TO MATCH MEIJER SPEC.
- PROVIDE A WET PIPE AUTOMATIC FIRE SPRINKLER SYSTEM FOR THE PUMP HOUSE.
   ELECTRICAL CONTRACTOR: TO PROVIDE ALL NECESSARY ELECTRICAL WORK FOR THE PRE FAB STRUCTURE. EC SHALL MOUNT / INSTALL THE FIRE PUMP CONTROLLER, JOCKEY PUMP CONTROLLER, WIRE /
- CONNECT JOCKEY & FIRE PUMP AND PROVIDE ALL NECESSARY CONNECTIONS / WIRE BETWEEN THE PUMPS, THE CONTROLLER AND THE TRANSFORMER. ELECTRICAL CONTRACTOR SHALL ALSO PROVIDE POWER TO PUMP HOUSE, PROVIDE GROUNDING AND CONFIRM COMPLIANCE WITH ALL LOCAL CODES.
- ALARM CONTRACTOR: TO PROVIDE ALL FIRE AND SECURITY ALARM SYSTEMS AND CONNECTIONS PER INDIANA CODE.
   SITE CONTRACTOR: TO PROVIDE TWO 10" DUCTILE
- UNDERGROUND FIRE LEAD INS FOR THE PUMP 12" ABOVE FINISH FLOOR AND TWO HOLED. SITE CONTRACTOR SHALL ALSO FLUSH BOTH CONNECTIONS AND PROVIDE AN NFPA ABOVE GROUND TEST CERT TO ROCKFORD CONST. 6. PUMP HOUSE PER PROVIDED SPEC
- 10.NOT INCLUDED: ROOF ACCESS, 2 HR FIRE WALLS, ELECTRICAL GROUNDING OF HOUSE, FOUNDATION, GRANULAR FILL, AND CONCRETE PAD ( DESIGN AND INSTALL ).


FIRE PROTECTION NOTES:

- FIRE PUMP: PEERLESS MODEL 6AEF14G (8X6) CAST IRON BRONZE FITTED UL LISTED AND FM APPROVED 1250 GPM @ 60 PSI FIRE PUMP DRIVEN BY A 60 HP, 1800 RPM 460V/3PHASE/60Hz, UL LISTED ODP MOTOR, ROTATION TBD. PUMP SIZE BASED ON FP
- DRAWINGS.
  2. MOTOR CONTROL: MANUAL AND AUTOMATIC, SOLID STATE CONTROLLER RATED FOR 60HP, 460V/3 PHASE/60HZ OPERATION WITH 100,000 AMP WITHSTAND RATING, NEMA TYPE 2 ENCLOSURE, SOFT START. NO TRANSFER SWITCH. CONTROLLER PROVIDED BY FP CONTRACTOR.
- JOCKEY PUMP AND JOCKEY PANEL: GRUNDFOS CR3-9 1.5HP, 460V, JOCKEY PUMP RATED FOR 8GPM @ 90 PSI, WITH TEFC MOTOR, CAST IRON BASE WITH 1" OVAL FLANGES.

JOCKEY PUMP MOTOR CONTROLLED BY A FIRETROL FTA550F 1.5 HP, MANUAL AND AUTOMATIC JOCKEY PUMP, INCLUDING PRESSURE SWITCH, DISCONNECT SWITCH AND HAND- OFF- AUTOMATIC SELECTOR SWITCH. CONTROLLER PROVIDED BY FP CONTRACTORR.

## NOTES: FURNISED AS CORRECTED FP ACTION: ADDED FDC CONNECTION TO WALL "C" AS REQUESTED.

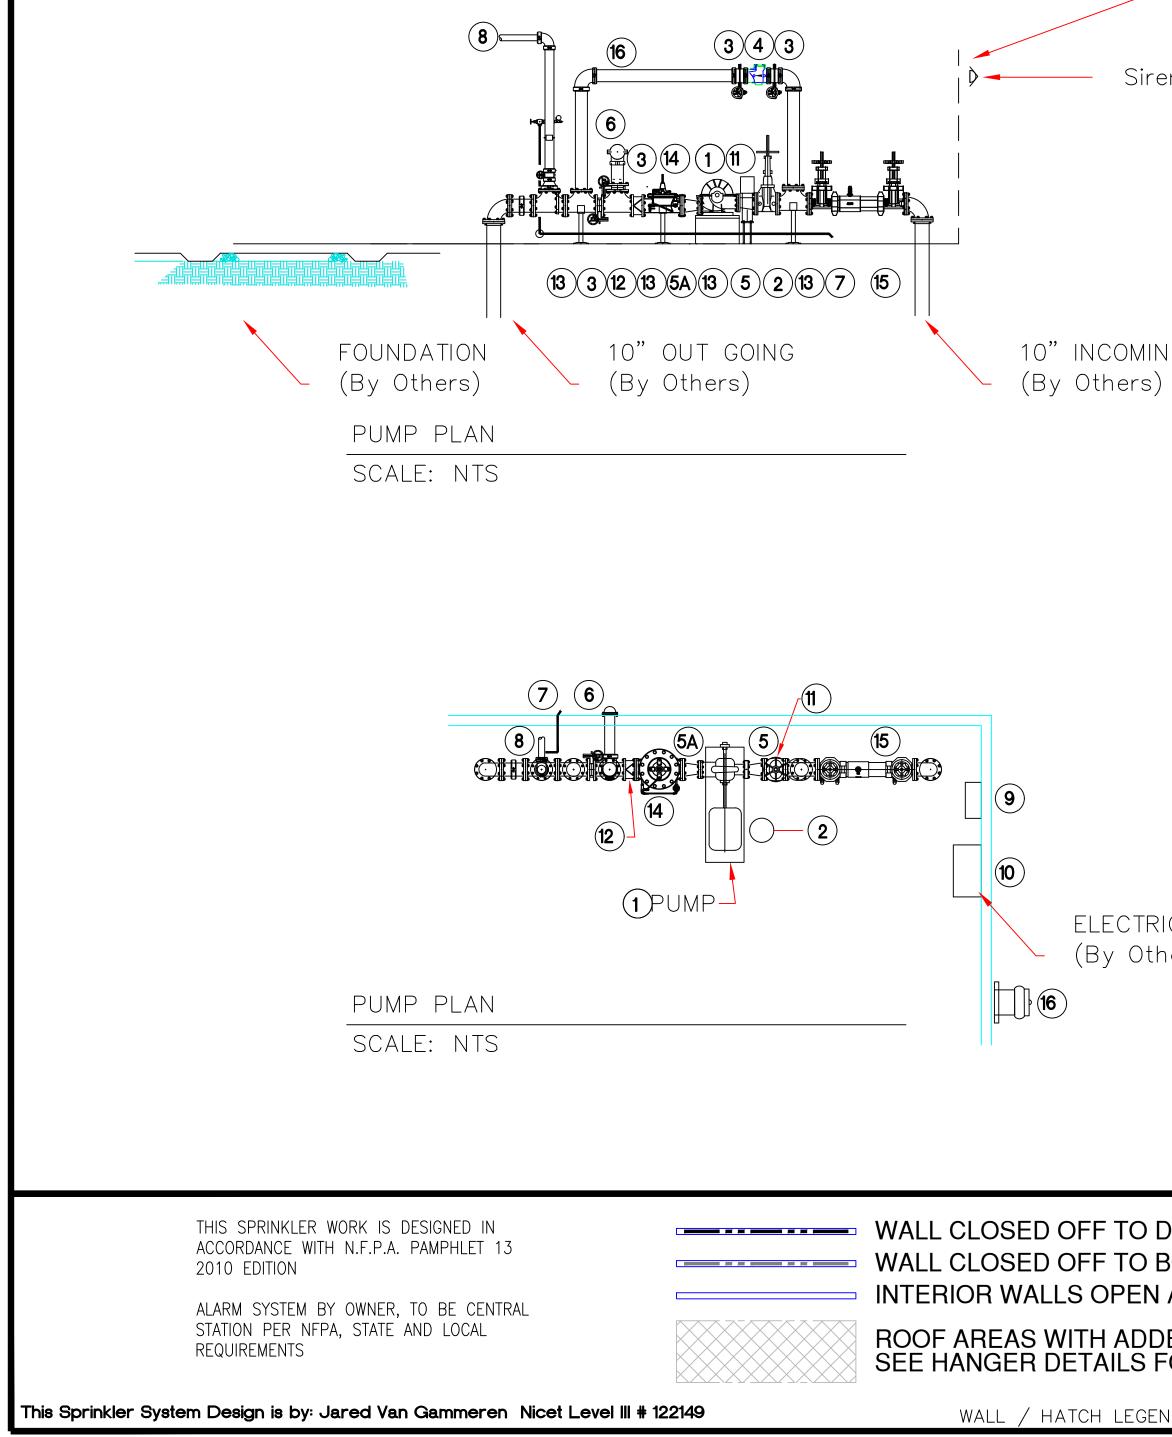

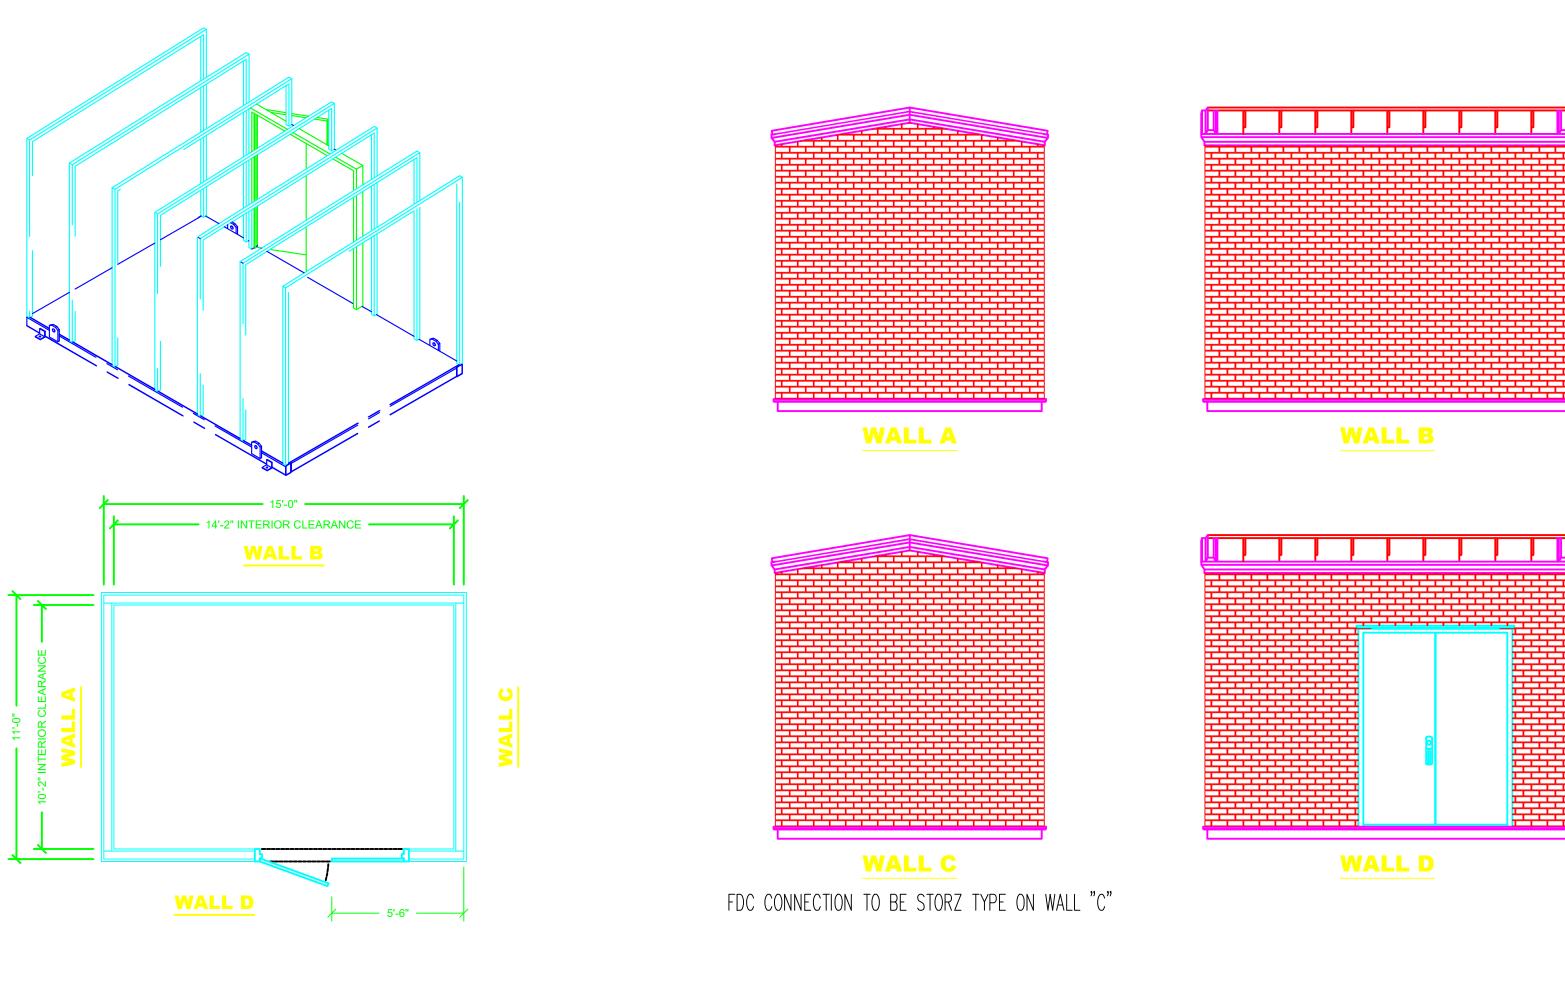




Siren-Strobe ( WALL D )

## MATERIAL LIST

		FIRE PUMP 1250 GPM & 60 PSI PER FP DRAWING & PAD
	2	JOCKEY PUMP 8 GPM & 90 PSI
NG	3	8" GROOVED END BUTTERFLY VALVE, WITH TAMPER SWITCH
)	4	8" GROOVED END CHECK VALVE
	5	8" X 5" FLANGED ECCENTRIC REDUCER
	<b>(5A)</b>	8" X 3" FLANGED CONCENTRIC REDUCER
	6	PUMP TEST HEAD
	7	2" MAIN DRAIN
	8	SPRINKLER RISER
	9	JOCKEY PUMP CONTROLLER
	(10)	FIRE PUMP CONTROLLER
	(11)	8" FLG. OS&Y CONTROL VALVE w/ TAMPER
	(12)	8" WAFER CHECK
	(13)	PIPE STAND
	(14)	LOW SUCTION
	(15)	8" AMES DOUBLE CHECK
	(16)	FDC COONECTION
RICAL hers)	16	FDC FIELD NOTE: FIELD LOCATE FDC CONNECTION ON WALL "C". CONNECTION TO BE STORZ TYPE. FDC SUPPY POINT SHALL BE ON THE SYSTEM SIDE OF THE BYPASS.

	SYM	CNT	POSITION	FINISH	TEMP	K	NPT	SIN	MFG.	MODEL#	ESCUTCHEON	CONTRACT	
DECK	$\otimes$	170	UPR	BRASS	214	25.20	1"	TY9128	Тусо	EC-25	NONE		
	$\boxtimes$	401	UPR	BRASS	200	14.00	3/4"	TY6137	Тусо	EC-14	NONE	ADDRESS:	
) BOTTOM OF JOIST	<u> </u>	91	UPR	BRASS	200	8.00	3/4"	TY4131	Тусо	TY-FRB	NONE	TADDICESS.	
	Ø	62	PEND	WHITE	200	14.00	3/4"	TY6237	Тусо	EC-14	SEMI-REC		REVI
N ABOVE CEILINGS	۲	27	PEND	WHITE	200	5.60	1/2"	TY323	Тусо	TY-FRB	SEMI-REC	DATE	DESCRI
		63	PEND	WHITE	200	5.60	1"	V3506	VIC	VS-1	SEMI-REC		
DED LOAD ALLOWANCES,	Ø	2	UPR	BRASS	200	14.00	3/4"	TY6137	Тусо	EC-14	NONE		
	$\odot$	1	UPR	BRASS	200	8.00	3/4"	TY4131	Тусо	TY-FRB	NONE		
S FOR MORE INFORMATION	$\triangleleft$	7	SIDE	BRASS	200	5.60	1/2"	TY3331	Тусо	TY-FRB	NONE		IMPOR
		824	TOTAL										NT FREEZING OF WATER IN
GEND	SPRINKLER HEAD LEGEND								TO PROVIDE SUFFICIENT HE R PIPES ARE INSTALLED, U				

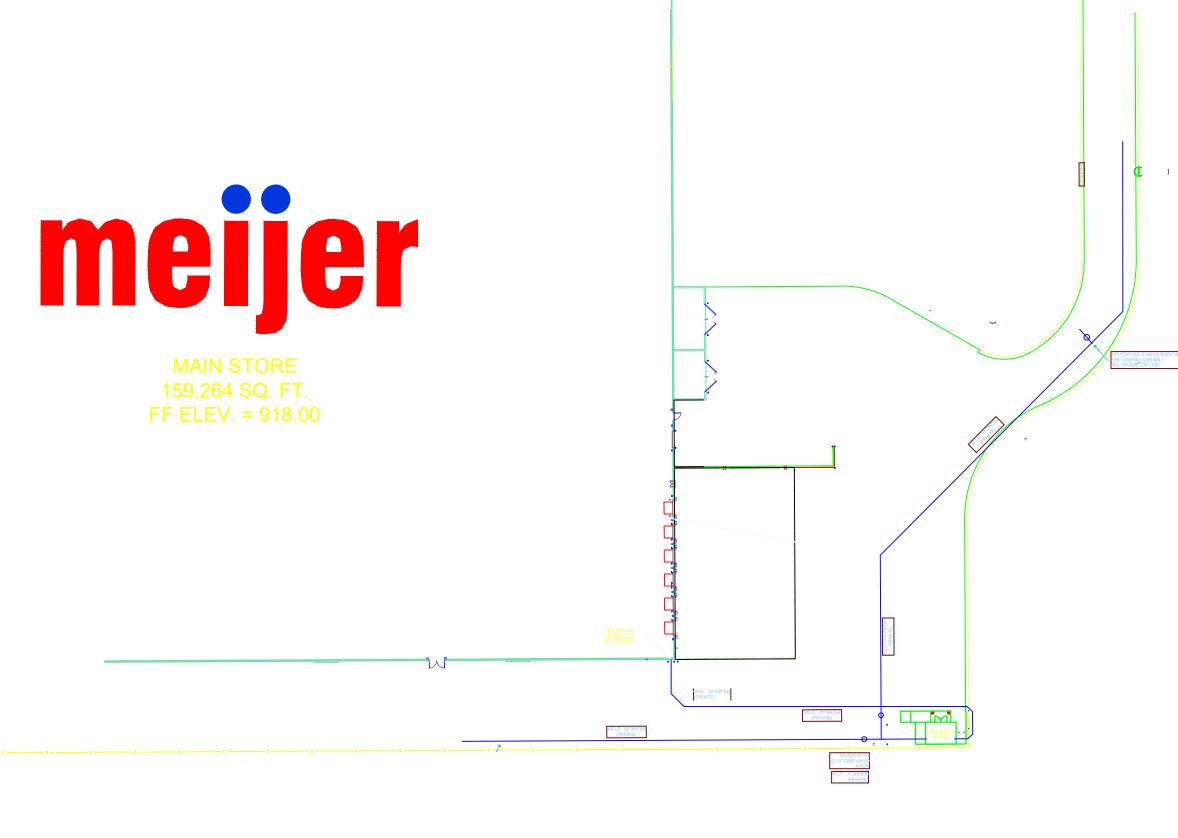



PARTIAL SITE UTILITY SCALE: NTS


		MEIJER STORE #319 225 W. SPRING MILL POINTE DR. HAMILTON COUNTY, WESTFILED, IN 460
VISION	BY	SPRINKLER PLAN
RTANT in wet pipe sprinkler pipi	NG.	
HEAT THROUGHOUT AREAS WH UNLESS AN ANTI-FREEZE SY	ERE	

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3	
80	
	NORTH
	DESIGNER JVG
	DESIGNER JVG SCALE $1/8$ " = 1'-0"
	DESIGNER JVG SCALE 1/8 " = 1'-0" CHECK BY RG
	DESIGNER JVG SCALE $1/8$ " = 1'-0"

DRAWING NO.FP-2 of 6

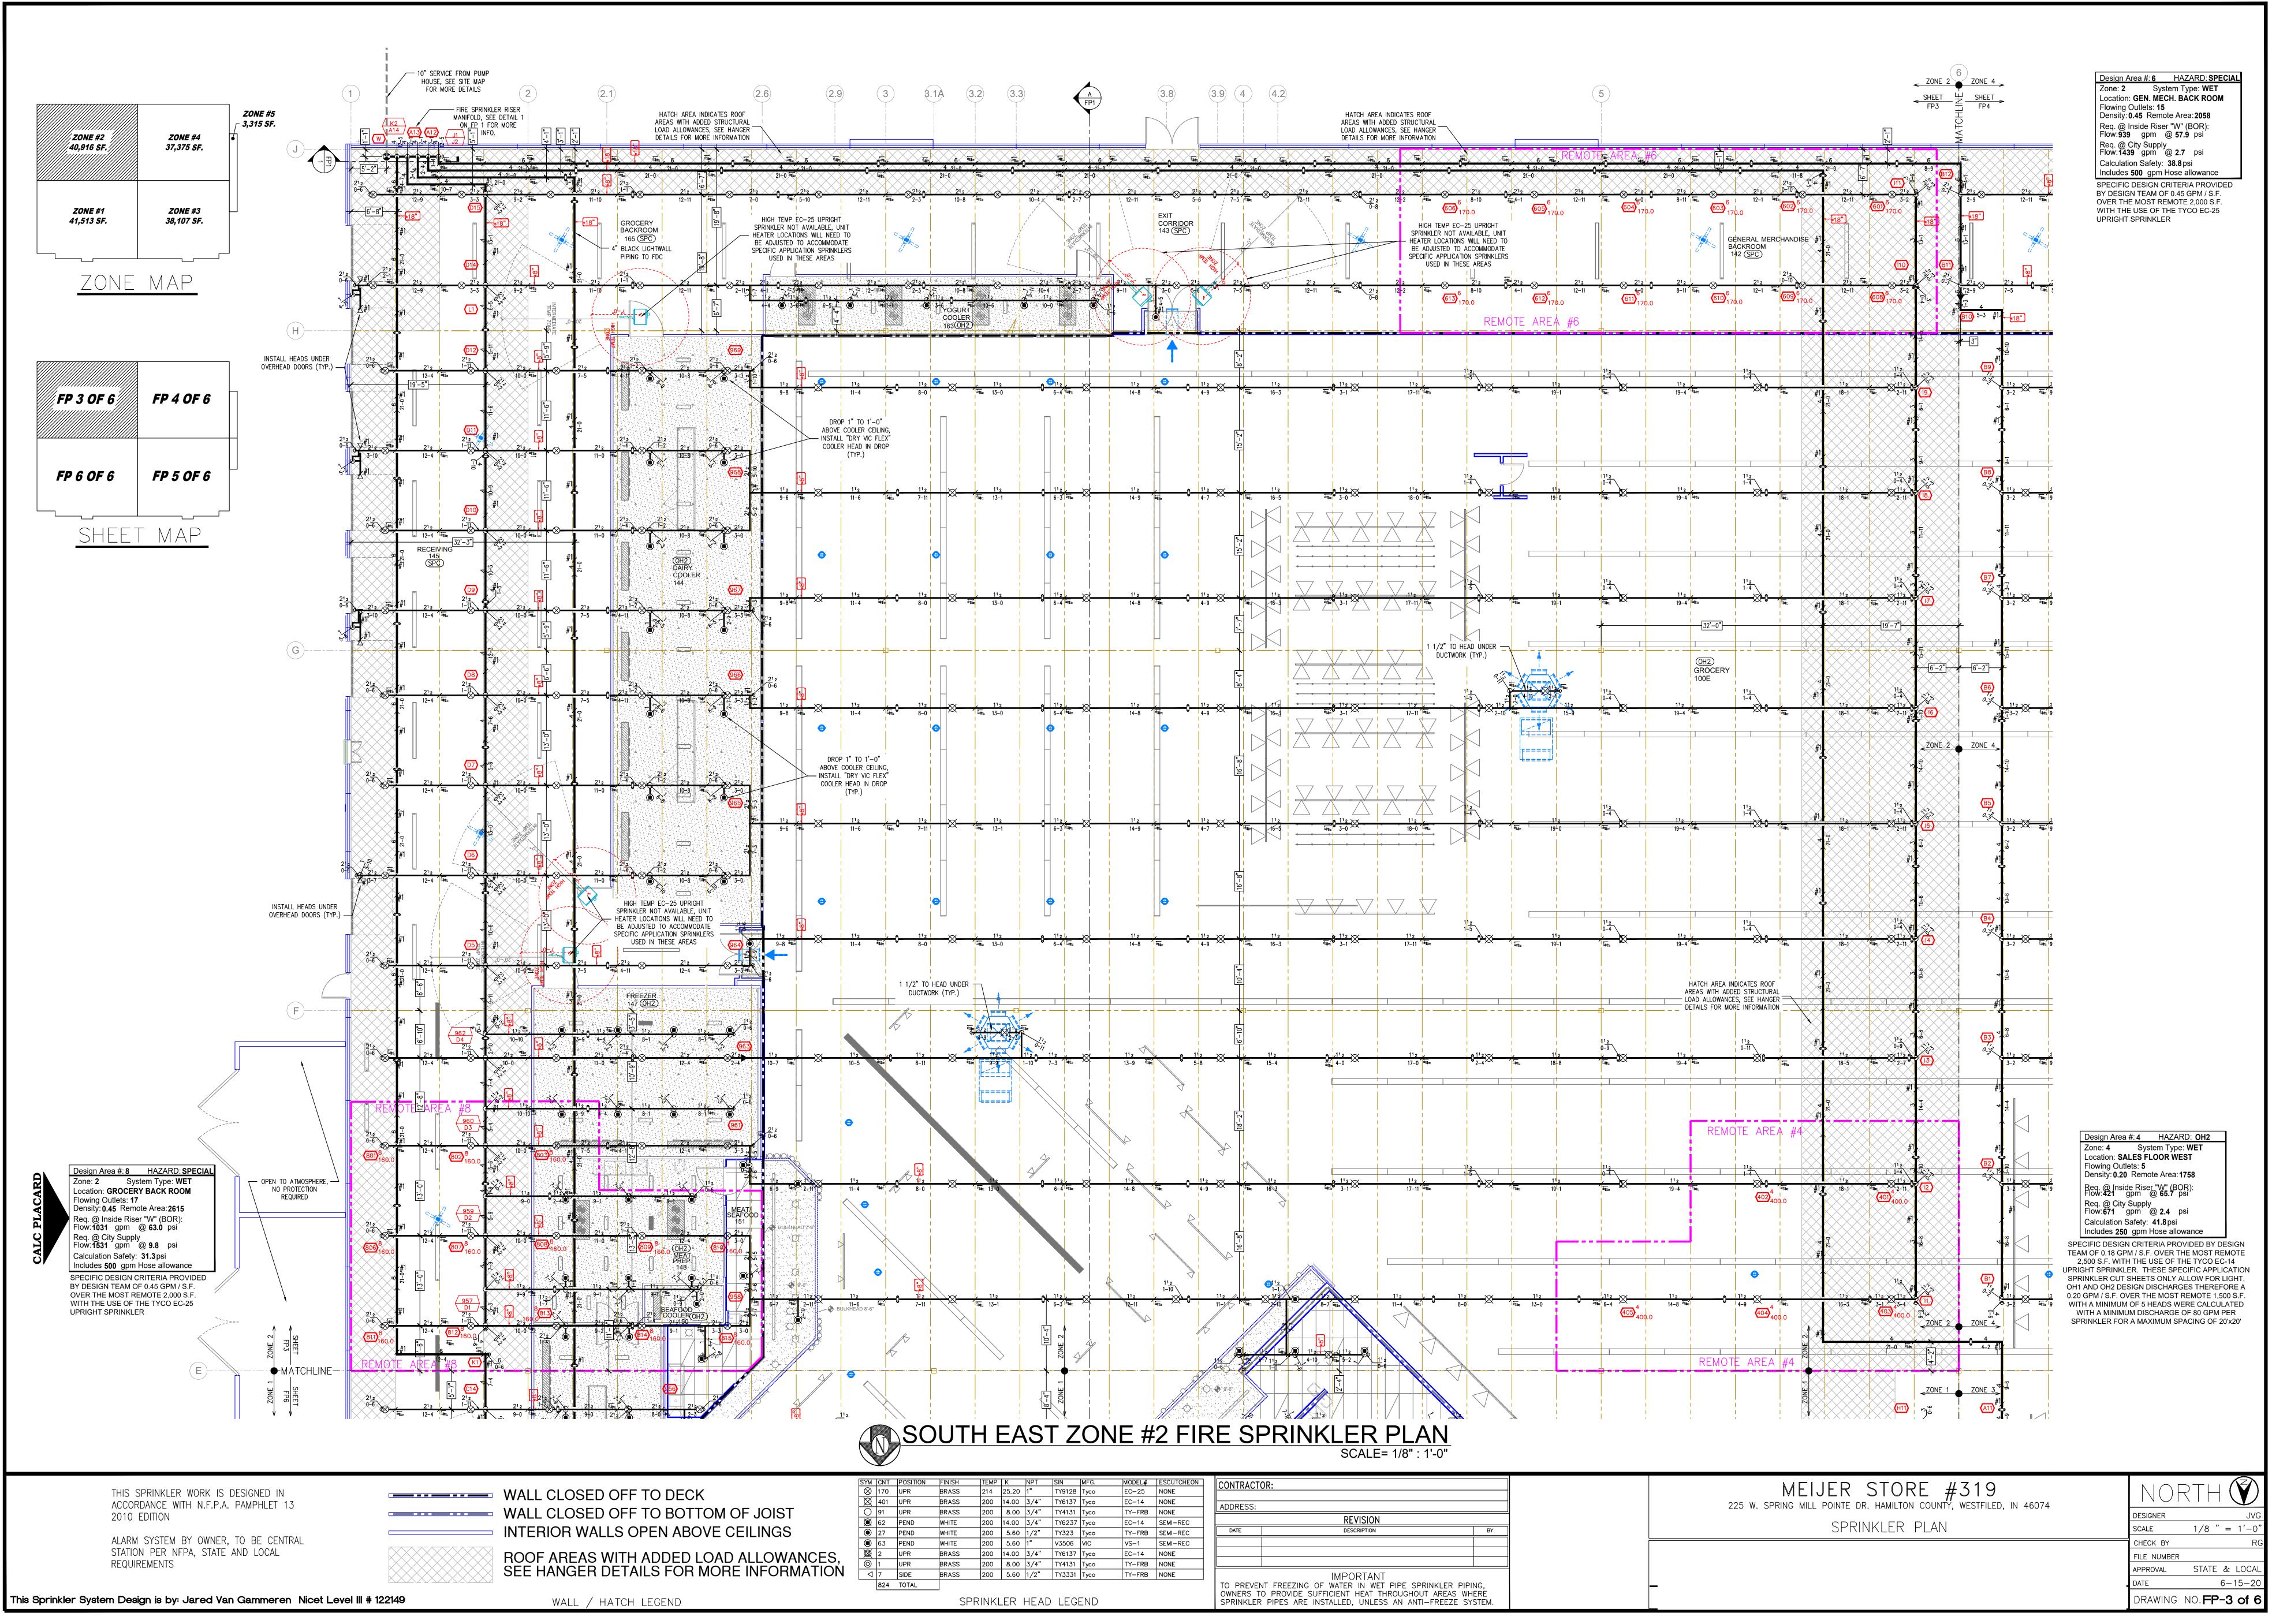

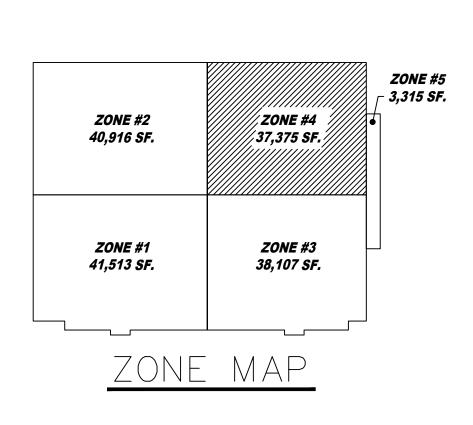

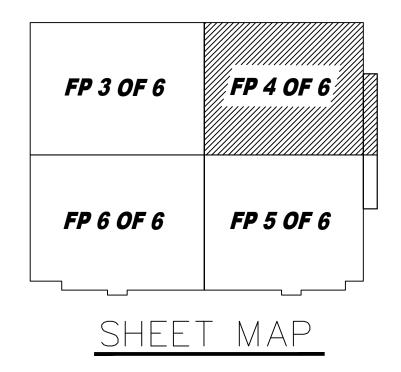

	6 ZONE 4 SHEET FP4 FP4			(		HATCH AREA INDIC REAS WITH ADDED OAD ALLOWANCES, ETAILS FOR MORE	CATES ROOF STRUCTURAL SEE HANGER INFORMATION				8			
6 8-9 9 2 7 3 2 7 2 7 2 7 2 7 2 7 2 7 2 7 2 7 2	9 1 2-9 4 1 1 2-9 4 1 1 1 1 1 1 1 1 1 1 1 1 1		HIGH TEMP EC-25 UPRIGHT SPRINKLER NOT AVAILABLE, UNIT HEATER LOCATIONS WILL NEED TO BE ADJUSTED TO ACCOMMODATE SPECIFIC APPLICATION SPRINKLERS	212 212 0-6 12-11 12-5	SF C EX IT CORR IDO 137 212 8-7	R 212 170.0 4-4 MEN'S 138	212 T 12-11 WOMEN' 0 139		3 REMO 9-1 TH	<b>7</b> 0 <b>4</b> <sup>7</sup> 170.0			127 702 728 127 702 72 128 127 128 128 128 128 128 128 128 128	212 212 11-7 2 2 2 2 2 2 2 2 2 2 2 2 2 2 2 2 2 2 2
	$\begin{array}{c}  & 2^{1}2 \\  & 2^{1}2 \\  & 72-9 \\  & 72-9 \\  & 72-9 \\  & 72-9 \\  & 72-9 \\  & 71 \\  & 10 \\  & 5-3 \\  & #11 \\  & 10 \\  & 5-3 \\  & #11 \\  & 10 \\  & 77 \\  $		USED IN THESE AREAS $2^{1}2$	DROP 1." J0 1'-0"	2 <sup>1</sup> 2 2 <sup>-3</sup> 2 <sup>-3</sup> 2 <sup>-9</sup> ALCOVE 140	2-1 3=10 175 170	212 2-1 2-1 0 0 0 0 0		212 9.0 <sup>12−11</sup> ₩ REMOTE	Z 2 1-1 2 1-1 1 1 1 1 1 1 1 1 1 1 1 1 1 1	BACKROOM 136	970 c c c c c c c c c c c c c c c c c c c		$\begin{array}{c} 3 \\ 3 \\ 2^{1}2 \\ 3 \\ 3 \\ 7 \\ 2^{1}2 \\ 2^{1}2 \\ 2^{1}2 \\ 2^{1}2 \\ 2^{1}2 \\ 3 \\ 3 \\ 7 \\ 7 \\ 1 \\ 1 \\ 1 \\ 1 \\ 1 \\ 1 \\ 1 \\ 1$
	#1 #1 #1 #1 #1 #1	$\frac{112}{3-2} \times \frac{1}{5}$	12 −0 10−4	ABOVE LAY IN CEILING, FLEX TO DROP (TYP.)	1 <sup>1</sup> 2 12−3	112, 7-1 \\	ULKHEAD 8'-6"	[-] [-]	-SERVICES 141	112 15-7		112 17-2 <sup>7</sup>	<b>0</b> <sup>11</sup> 2 2-2	→ 11 <sub>2</sub> → 18 <u>1</u> 10 ≒
	4 1 1 1 1 1 1 1 1 1 1 1 1 1	$\frac{112}{3-2}$ $\xrightarrow{1}$		$ \begin{array}{c} 11_{2} \\ 10-8 \\ \hline \hline$	<u>112</u> 12-3	1 <sup>1</sup> 2, 7-1≒	1 <sup>1</sup> 2 13-11 \\		<u>12</u> →5	<u>112</u> 15-7	→112 3-10 ×	1 <sup>1</sup> 2 17-2	Q <sup>11</sup> 2 2-2	→ 112 → 18+10 →
	#		12 -0 0 112 10-4 ≒	$ \begin{array}{c ccccccccccccccccccccccccccccccccccc$		112, 7-1₩±	1 <sup>1</sup> 2 13–11			112 15-7	⇒ 0 112 ×	112 17-2 <sup>7</sup> #=	<b>0</b> <sup>11</sup> 2 2-2	112 112 112 112 112 112 112 112
				$\begin{array}{c} 2 \\ 112 \\ 9-4 \\ 1^{1}2 \\ 0-11 \\ 0 \\ 1^{1}2 \\ 0-11 \\ 0 \\ 0 \\ 0 \\ 0 \\ 0 \\ 0 \\ 0 \\ 0 \\ 0 \\$	E 112 E 12−3	112, 7-15#= X	112 13-11	8'-4"		112 15 <sup>1</sup> 7		112 17-2 ===	. Q <sup>11</sup> 2 2-2	1 1/2" TO HEAD UNDER - DUCTWORK (TYP.)
	ZONE 4				<u>112</u> <u>12-3</u>	112 7-15=	112 13-11		<u>12</u> −5	11 <sub>2</sub> 15 <sup>1</sup> 7		112 17-2 <sup>-5</sup>	0 <sup>112</sup> 2×	
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						7-11 ** ××	13-11 ¥¥	-10" -10" 		15 <sup>⊥</sup> 7 <sup>≤</sup>		17-2´₩     	• • <sub>2-2</sub> ××	
	4 4 11 11 11 11 11 11				2 112 12-3	1 <sup>1</sup> 2, 7-1 <sup>5</sup> X	112 13-11					112 17-2	<b>0</b> <del>11 2</del> <del>2</del> <del>2</del> <del>2</del> <del>2</del> <del>2</del> <del>2</del> <del>2</del> <del>2</del> <del>2</del>	
		2 112 3-2 3=2 3=2 3=19 119 119	12 112 X -0 10-4 1 HARDLIN 100F	112 10-8 5₩2 0 112 8-9 ∞ 5 8-9	, 112 ≓ 12-3	<u>112,</u> 7-1≆⊨ X	112 13-11		12 X ¥	112 15⊥Z ≦	1 <sup>1</sup> 2     3−10     3−10	<u>112</u> 17-2		11₂ 11₂ 3₩± 18⊥10_ 3
				112 10-8 $128-9$ $5$	↓ <u>112</u> ► 12-3	<u>112,</u> 7-1≒⊨ X	112 13-11		12 X ¥	112 15 <sup>1</sup> 7	#= 0 112 3−10 × 1	11 2 17-2 <sup>-</sup>		11₂ 11₂ ₩ 18-10 ¥
	$\frac{4}{4-2} #1$ $\frac{20 \text{NE}}{3} = \frac{3}{3}$ $\frac{1}{4}$ $\frac{1}{4}$													
			WALL CLOSED	OFF TO DECK OFF TO BOTTOM O LS OPEN ABOVE CE		SYM ( SYM ( SY	CNT POSITION 170 UPR 401 UPR 91 UPR 62 PEND 27 PEND	FINISH BRASS BRASS BRASS WHITE WHITE		NPT         SIN         MF           1"         TY9128         Ty           3/4"         TY6137         Ty           3/4"         TY4131         Ty           3/4"         TY6237         Ty	G.         MODEL#           co         EC-25           co         EC-14           co         TY-FRB           co         EC-14	ESCUTCHEON NONE NONE SEMI-REC SEMI-REC	-	SPRINK SPRINK
				VITH ADDED LOAD		S, S, ON ⊲	FEND           63         PEND           2         UPR           1         UPR           7         SIDE           824         TOTAL	WHITE BRASS BRASS BRASS	200 5.60 200 14.00	1"         V3506         VIO           3/4"         TY6137         Ty           3/4"         TY4131         Ty	VS-1           co         EC-14           co         TY-FRB	SEMI-REC NONE NONE		IMPORT FREEZING OF WATER IN PROVIDE SUFFICIENT HEA

THIS SPRINKLER WORK IS DESIGNED IN ACCORDANCE WITH N.F.P.A. PAMPHLET 13 2010 EDITION


ALARM SYSTEM BY OWNER, TO BE CENTRAL STATION PER NFPA, STATE AND LOCAL REQUIREMENTS


This Sprinkler System Design is by: Jared Van Gammeren Nicet Level III # 122149

WALL / HATCH LEGEND

SPRINKLER HEAD LEGEND

IMPORTANT TO PREVENT FREEZING OF WATER IN WET PIPE SPRINKLER PIPING, OWNERS TO PROVIDE SUFFICIENT HEAT THROUGHOUT AREAS WHERE SPRINKLER PIPES ARE INSTALLED, UNLESS AN ANTI-FREEZE SYSTEM.

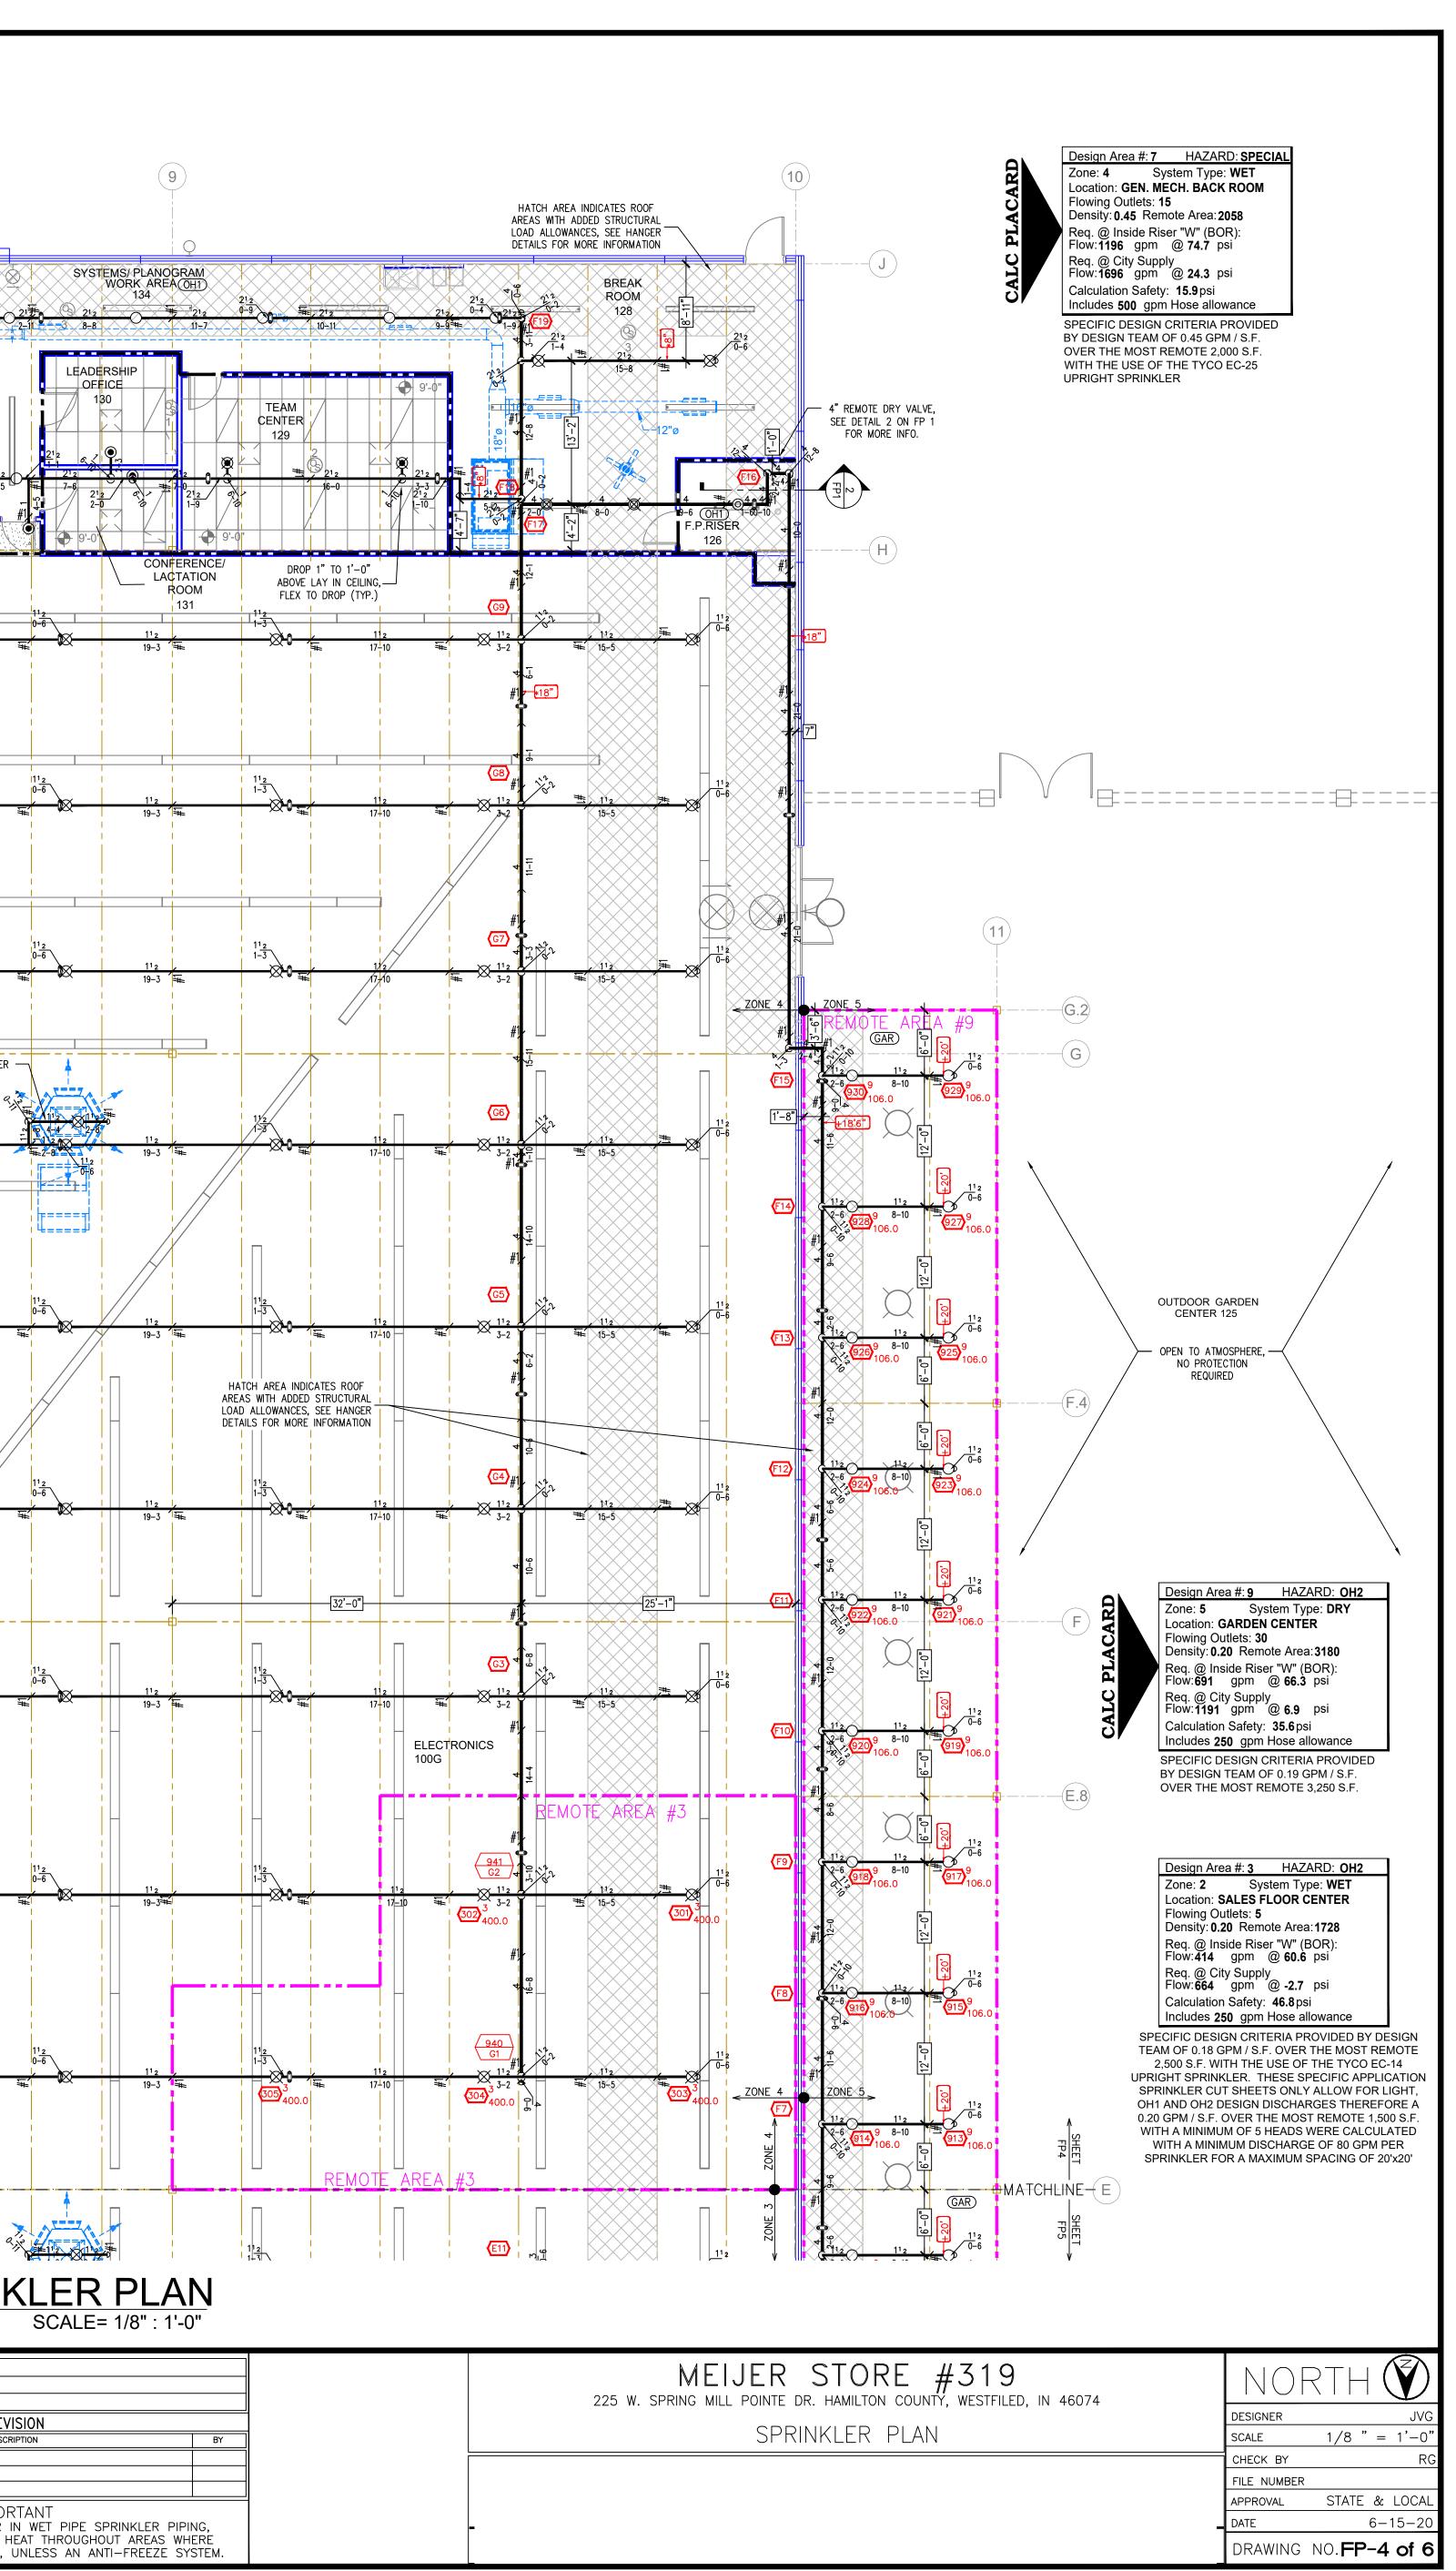


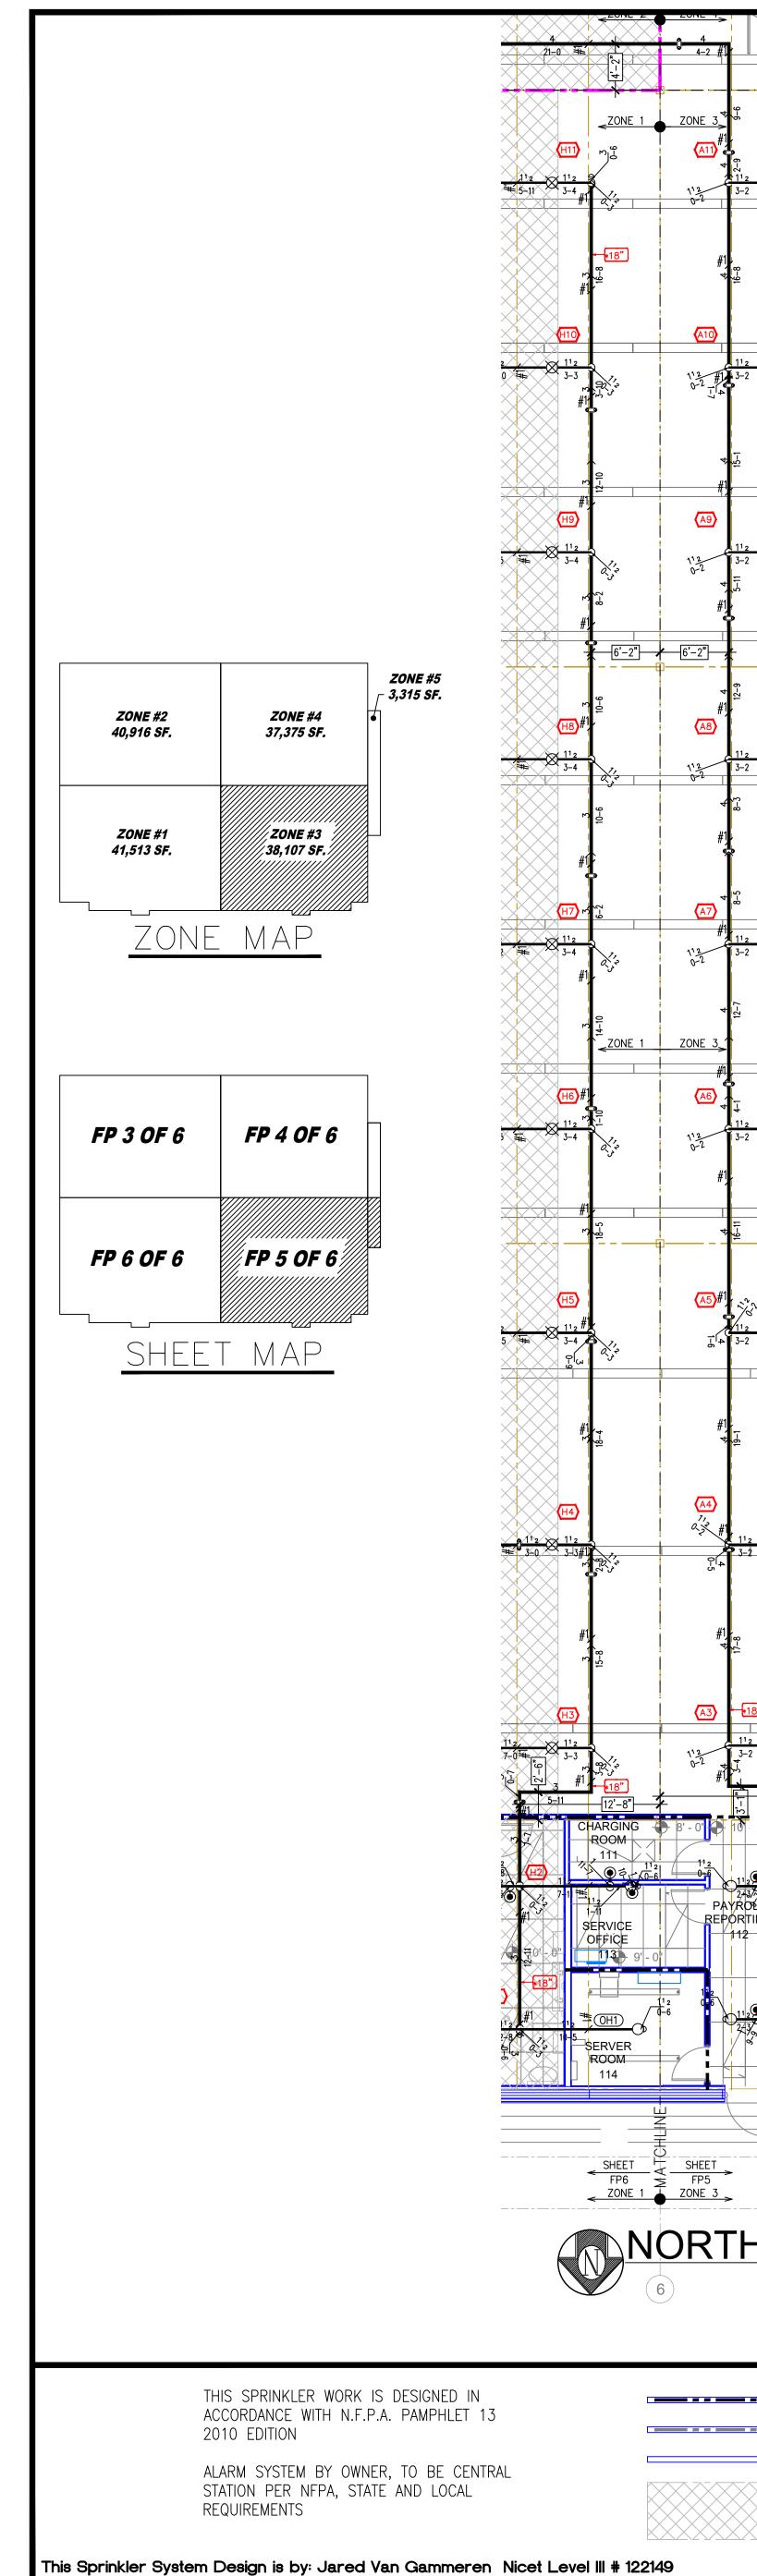


10-4 10-8 👾 ₩ 9-0 ₩≨| 9-0 10-4 10-8 ₩ 9-0 <u>10</u>-74 ́ ।≒ | 10−8 👾 FASHION | 100B 10-4 🚟 🗙 ₩ 9-0 ₩1 9-0 10-8 10-4 1= ₩ 9-0 10−4 ´|ॠ | 10−8 ≒≢≦| 1 1/2" TO HEAD UNDER -DUCTWORK (TYP.) . \_ \_ \_\_\_\_ \_ \_ \_ \_ \_ \_\_\_ \_ \_ \_ ₩ 9-0 10-4 ≒ <u>3-2 ~</u> \_\_\_\_\_19-0 ÉĦ 17-10 (A3) + \*18" ⊥ BULKHEAD ₩ 9-0 10-8 10-4 / 7" 18–8 INSTALL LONG ARM OVERS HIGH WITH LONG DROP PAYRO∳L A.P. OFFICE/ 10NITORING ROOM -115-<u>₩</u>8-10 NORTH WEST ZONE #3 FIRE SPRINKLER PLAN SCALE= 1/8": 1'-0"

WALL CLOSED OFF TO DECK WALL CLOSED OFF TO BOTTOM OF JOIST INTERIOR WALLS OPEN ABOVE CEILINGS

WALL / HATCH LEGEND

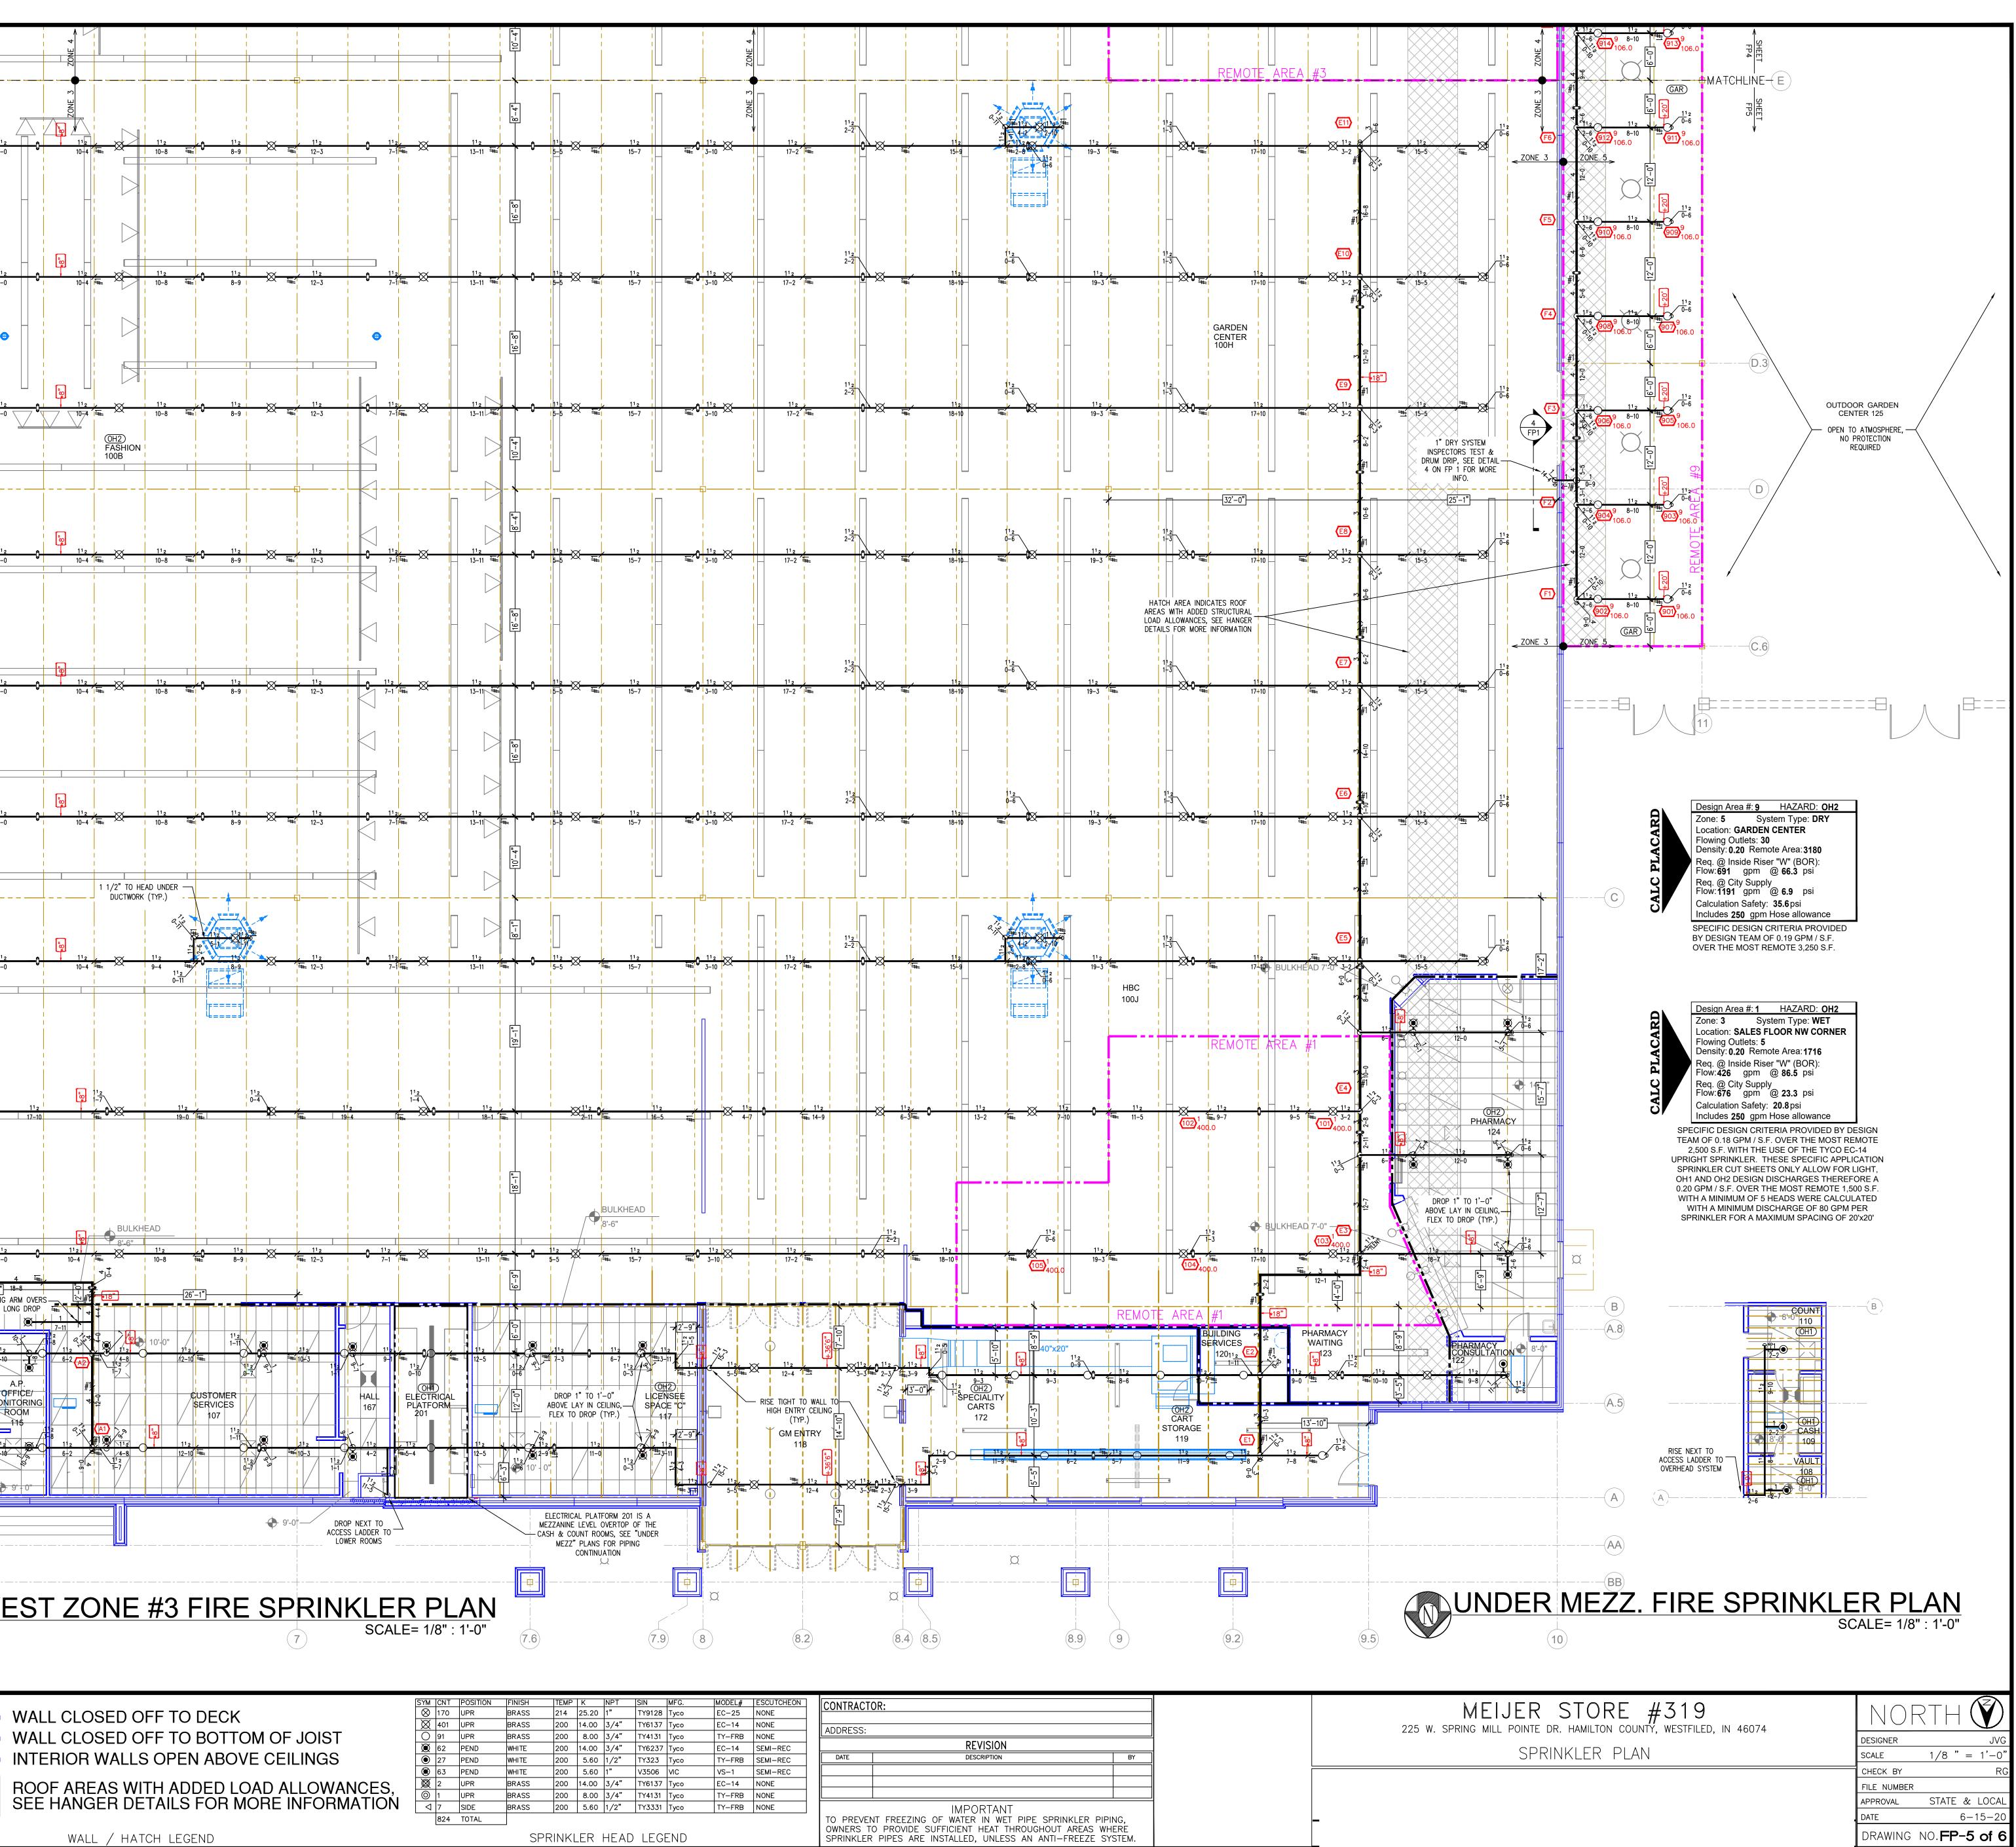

APPROVAL	STATE & LO
DATE	6-15-
DRAWING	NO. FP-5 of

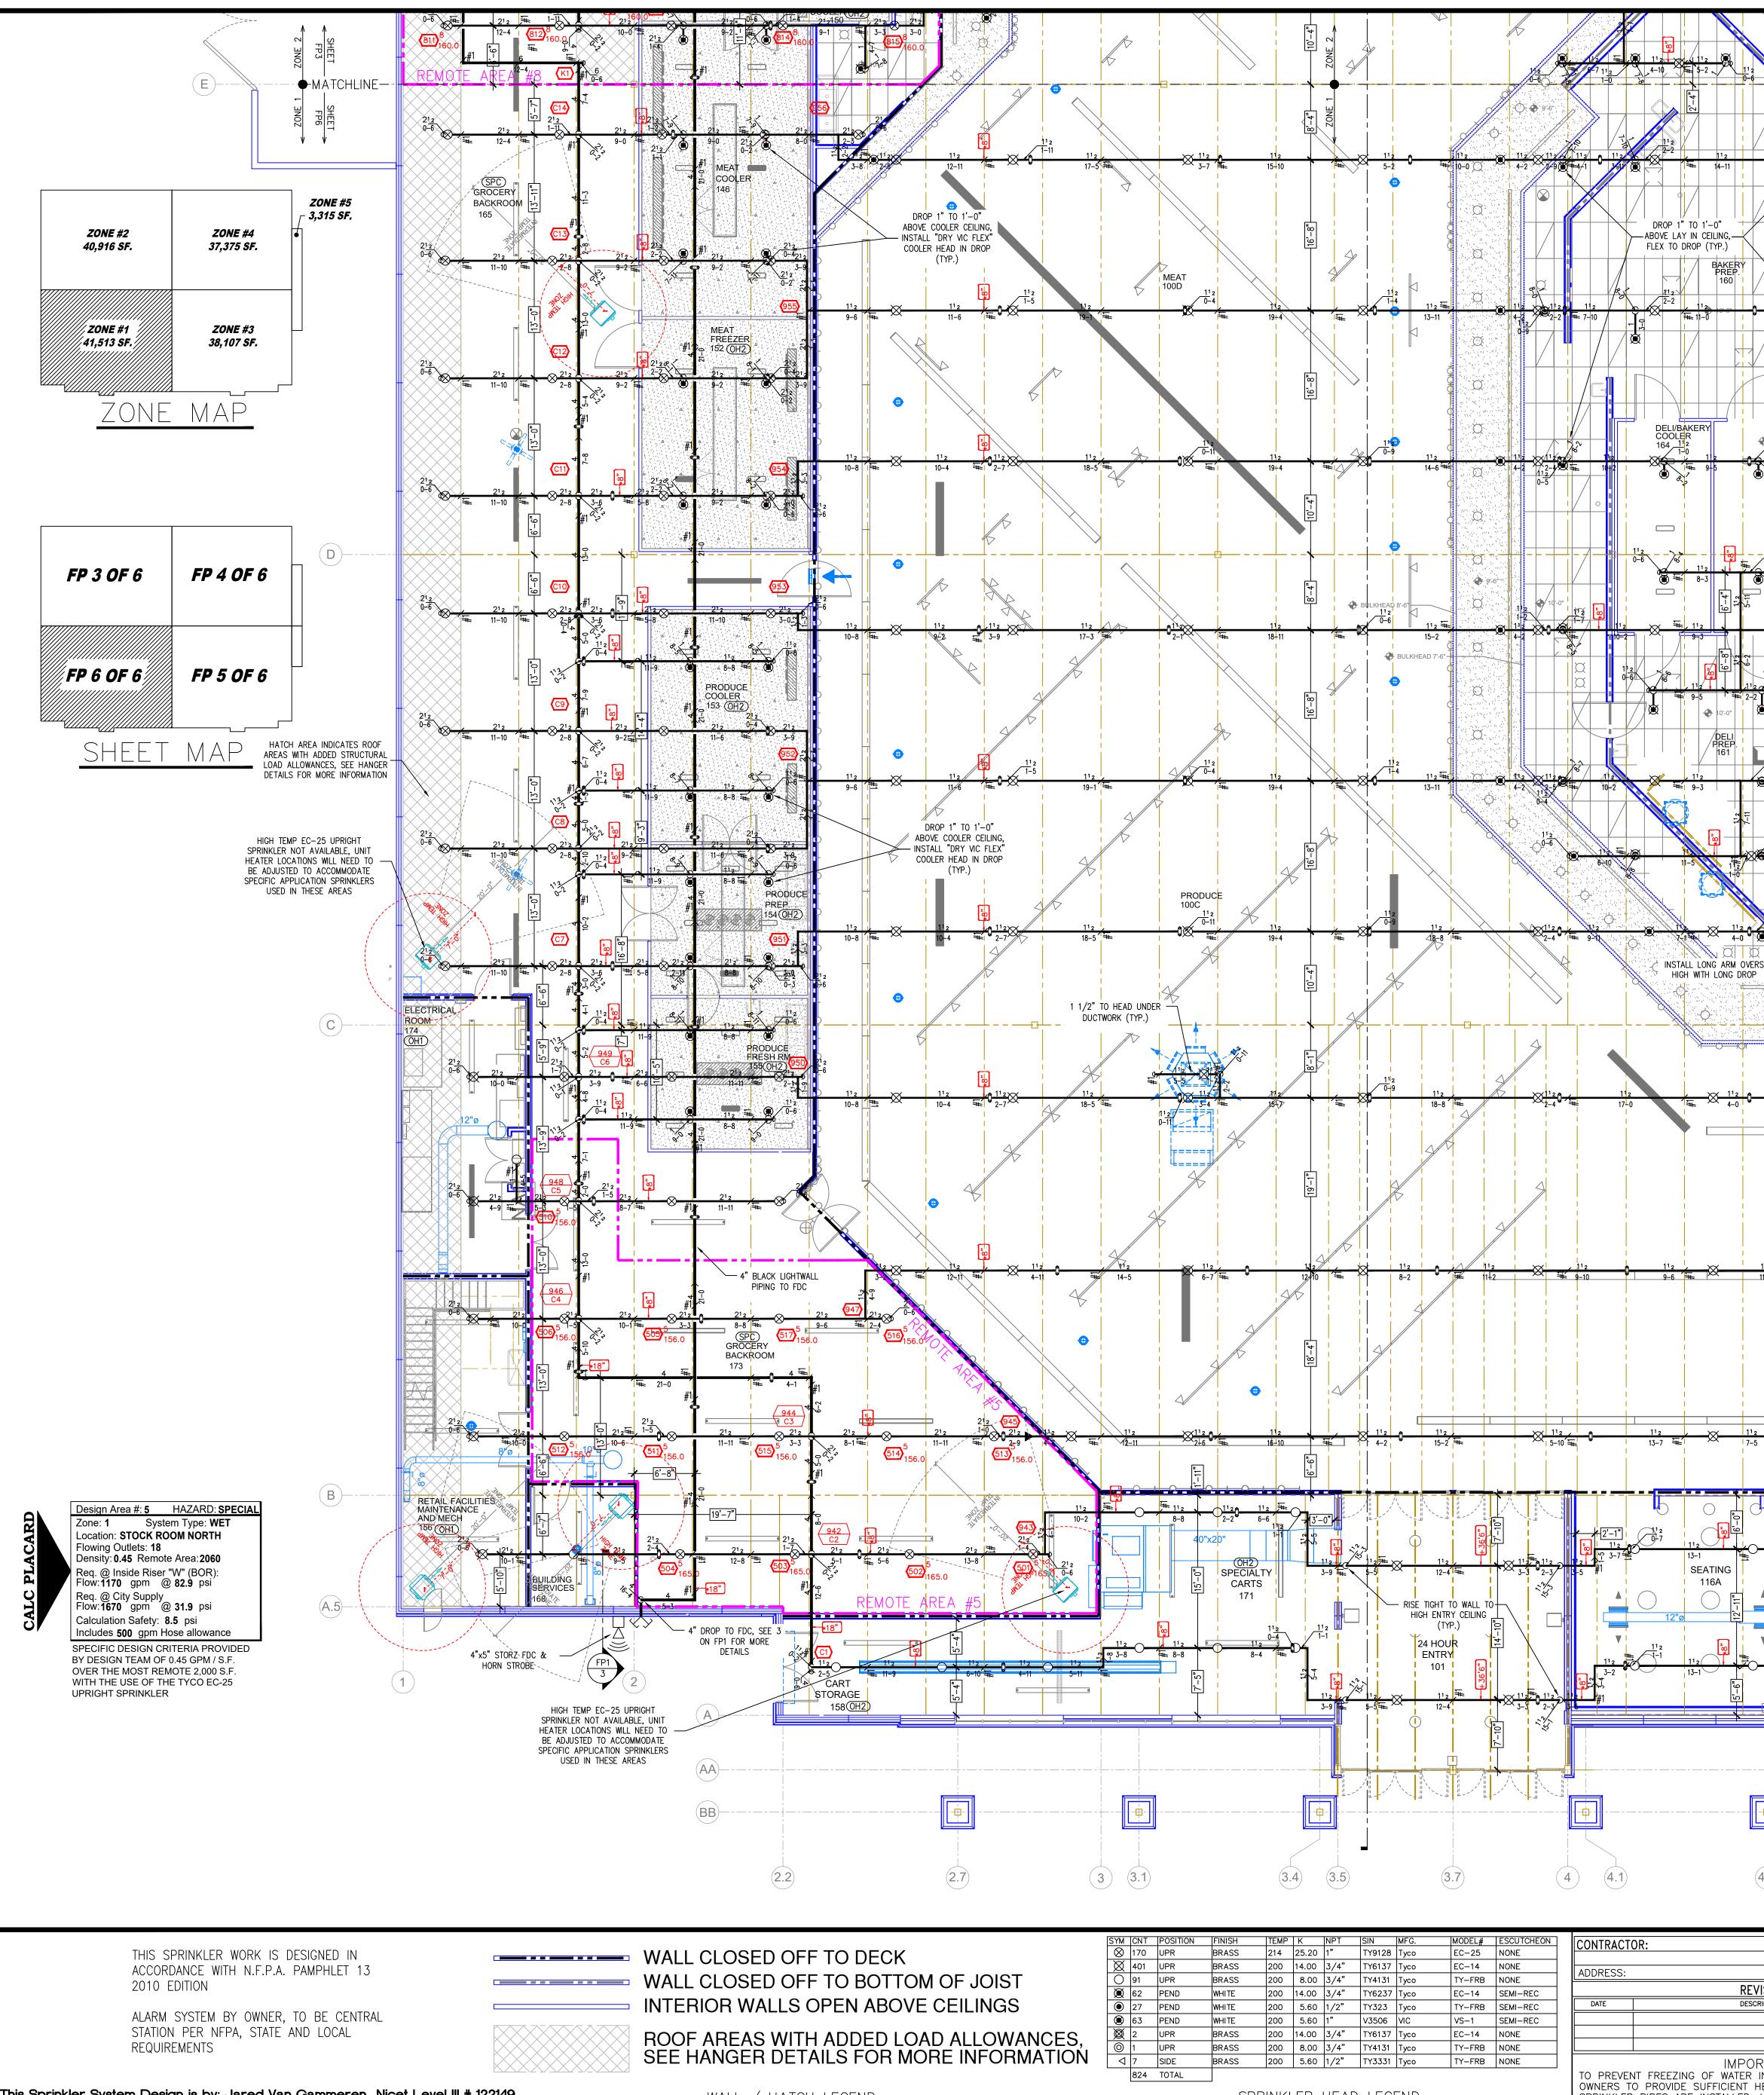

This Sprinkler System Design is by: Jared Van Gammeren Nicet Level III # 122149

WALL / HATCH LEGEND

SPRINKLER HEAD LEGEND

TO PREVENT FREEZING OF WATER IN WET PIPE SPRINKLER PIPING, OWNERS TO PROVIDE SUFFICIENT HEAT THROUGHOUT AREAS WHERE SPRINKLER PIPES ARE INSTALLED, UNLESS AN ANTI-FREEZE SYSTEM.

		400.0			ZONE 2	ZONE 4
			REMOTE ARI	A #4		ZONE 3 #1
2-11 X 12-11 12-11	× ↓ 1 <sup>1</sup> 2 ↓ 3-8	$ \begin{array}{c c} 1^{1}_{2} \\ 9-3 \\ \hline 11-9 \\ \hline \end{array} $		112 112 13-5	H11 H11 m <sup>2</sup> m <sup></sup>	$\begin{array}{c c} & & & & \\ & & & & \\ & & & \\ & & & & \\ & & & & \\ & & & & \\ & & & & \\ & & & & \\ & & & & \\ & & & & \\ & & & & \\ & & & & \\ & & & & \\ & & & & \\ & & & & \\ & & & & \\ & & & & \\ & & & & \\ & &$
						#1, **-
					₩ <sup>2</sup> #1	
	11 € 0-4	112 12-11 THE 77-9	<u>112</u> 11−7 X	112 ₩±1 9-5	11 <sup>1</sup> 2 10-0 ## 3-3 #10-0 ## #11	$\begin{array}{c} 11_{2} \\ 11_{2$
			•			+ 
916 <sup>2</sup> 112       1-0     112					ен 13-14 13-14 13-14	#1 (A9)
7-11 DELI/BAKERY RREEZER 162	2 9 X		112 × ×	112 ₩ 8-11		$\begin{array}{c c} & 112 \\ & 112 \\ & 13-2 \\ & & & & \\ & & & & \\ & & & \\ & & & & \\ & & & & \\ & & & & \\ & & & & \\ & & & & \\ & & & & \\ & & & & \\ & & & & \\ & & & & \\ & & & & \\ & & & & \\ & & & & \\ & & & & \\ & & & & \\ & & & & \\ & $
					#1 6'-2"	
					р <u>1</u> ( <del>18)</del> (18)	4 [1] [12-9
112 == 112 9=8 : 11=4 WAREWASH 159	₩ ₩		11 2 12-10			$\begin{array}{c ccccccccccccccccccccccccccccccccccc$
					# <u>1</u>	#1) *
2-2 7-6 112 3-11 112 112 112 112 112 3-11		1 <sup>1</sup> 2 xx 1 <sup>1</sup> 2 A	1 <sup>1</sup> 2 XX			$(A7)^{4} \stackrel{1}{\omega}^{1}$
		12-11 13 6-6	₩ 12-10 HATCH AREA INDICATES R AREAS WITH ADDED STRUC		$\begin{array}{c ccccccccccccccccccccccccccccccccccc$	1 <sup>1</sup> 2 0-2 13-2 ₩ 9-0
$\begin{array}{c ccccccccccccccccccccccccccccccccccc$			LOAD ALLOWANCES, SEE H/ DETAILS FOR MORE INFORM	ANGER 🔨		ZONE 3
$\begin{array}{c ccccccccccccccccccccccccccccccccccc$	11 <sup>2</sup> 0-10	112 12-11 ¥ 7-3	112 ¥12-1		$H6 #1 \\ H6 H6 H6 \\ H6 H6 \\$	$A60 + \frac{112}{13-2} \times \frac{112}{572} + \frac{112}{9-0}$
						0-2 #1
	] 					
<u> </u>	11 2 5-8		275 4 275 275 4 275 275 275 275 275 275 275 275	112 The 8-11		(A5)#1 $(112)$ $(11$
		REMO1	e area #2			#1,  -
112 112	, 112	n 1 <sup>1</sup> 2 x XX 1 <sup>1</sup> 2	<u>e</u> 112 XX			
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					۲ 1-8 1-1 1-8	#1,′. *
e 1 <sup>1</sup> 2 ××	, 1 <sup>1</sup> 2 <b>6</b>	1 <sup>1</sup> 2 / XX 1 <sup>1</sup> 2				
	₩1 9-1 000ULKHEAD 8'-6"	10-3 ₩ 204 204 400.0 REMOTE AREA #2	₩ 8-7 203	2 ¥2 12-5 400.0	7-0 <sup>5</sup> 7-0 <sup>5</sup>	1 <sup>2</sup> 0 <sup>-2</sup> #1 1 <sup>3-2</sup> 1 <sup>3-8</sup> 1 <sup>3-9</sup> 1 <sup>3-9</sup> 1 <sup>3-9</sup> 1 <sup>3-8</sup> 1 <sup>3-9</sup> 1 <sup>3-</sup>
	X /	$\begin{array}{c} \bullet & 10' - 0'' \\ \hline & 11'2 \\ 1 - 5_{1'2} \\ \hline \\ \bullet & \bullet \\ \end{array}$		+ 10' - 0' ALCOV		B' - 0' INSTALL LONG ARM HIGH WITH LONG
7-4 6-4 ₩ 2-4 (0H2)	10-11 🗮			112 112 112 112 5 0 2 6 7 9 FAMILY RESTROOM	2-50 2-50 412 2-50 412 7-11 1-11 1-11 SERVICE OFFICE	PAYROEL REPORTING A.P
LICENSEE SPACE 'B' 116		ABOVE LAY IN CEILING, – FLEX TO DROP (TYP.)	MEN 105	0 103	WOMEN 65 70 - 6"	
112 6-10 112 6-10 112 2-4	κ / 1 <sup>1</sup> 2	$\begin{array}{c c} 11_2 \\ \hline 0-11 \\ \hline 0 \\ \hline 11_2 \\ \hline 8-2 \\ \hline 4-3 \\ \hline \end{array}$		q12         Q ==         11           7-5         0         5-1           0         0         0	● 112 #1 112 = OH1 0 2-8 0 2 0 0 0 0 0 0 0 0 0 0 0 0 0 0 0 0 0	
					ZONE 1	SHEET FP5 ZONE 3
	N	ORTH EAS	T ZONE	<u>#1 FI</u>	RE SPRINK	<b>SCALE= 1/8" : 1'-0</b>
4.4		5				6
			2	225 W. SPRING	EIJER STORE MILL POINTE DR. HAMILTON C	H319 (OUNTY, WESTFILED, IN 46074
/ISION RIPTION	BY				SPRINKLER P	
RTANT						

Flowing Out Density: 0.20 Req. @ Insi Flow: 420 Req. @ City Flow: 670 Calculation Includes 250 SPECIFIC DESIG TEAM OF 0.18 GF 2,500 S.F. WIT UPRIGHT SPRINKI SPRINKLER CUT OH1 AND OH2 DE 0.20 GPM / S.F. C WITH A MINIMUM WITH A MINIM	System Type: WET ALES FLOOR NORTH tlets: 5 0 Remote Area:1616 de Riser "W" (BOR): gpm @ 71.3 psi
	$NORTH \qquad \qquad$
	CHECK BY RG FILE NUMBER APPROVAL STATE & LOCAL DATE 6-15-20
	DRAWING NO.FP-6 of 6