


A BUILDING SECTION
SCALE: 3/32" = 1'-0"

- GENERAL NOTES**
- INDIANA BUILDING CODE (2014)
 - OCCUPANCY/BUSINESS (B); ASSEMBLY (A2&A3)
 - TYPE OF CONSTRUCTION IIB
 - SPRINKLERED AREAS (APPROXIMATE - SEE ARCHITECTURAL PLANS FOR ACTUAL)


TOTAL	= 161,226 S.F.
ZONE #1 WET	= 41,513 S.F.
ZONE #2 WET	= 40,916 S.F.
ZONE #3 WET	= 38,107 S.F.
ZONE #4 WET	= 37,375 S.F.
ZONE #5 DRY	= 3,315 S.F.
 - INSTALLATION STANDARDS:

SPRINKLER SYSTEM DESIGNED AND INSTALLED PER NFPA-13 & NFPA 20(2010)
 - SPRINKLER PIPE TYPES:
 - 1" BRANCH LINES TO BE BLK MEGA THREAD PIPING WITH THREADED FITTINGS
 - 1/2" THROUGH 6" MAIN & BRANCH LINES TO BE BLK MEGA FLOW PIPING WITH GROOVED FITTINGS
 - 1" BRANCH LINES TO BE THREADED GALV SCHEDULE 40 WITH GALV THREADED FITTINGS
 - 1/2" THROUGH 4" MAIN & BRANCH LINES TO BE GROOVED GALV SCHEDULE 10 WITH GALV GROOVED FITTINGS
 - DESIGN CRITERIA
 - AREAS NOT MARKED BY A HAZARD TAG WILL BE DESIGNED AS A LIGHT HAZARD, AREAS WILL BE DESIGNED TO DELIVER 0.10 GPM/S.F. OVER THE MOST DEMANDING 1500 S.F.
 - ORDINARY HAZARD GROUP 1 AREAS DESIGNED TO DELIVER 0.15 GPM/S.F. OVER THE MOST DEMANDING 1500 S.F.
 - SALES FLOOR AREAS WILL BE DESIGNED AS AN ORDINARY HAZARD GROUP 2, AREAS WILL BE DESIGNED TO DELIVER 0.20 GPM/S.F. OVER THE MOST DEMANDING 1500 S.F.
 - STOCK ROOM AND STORAGE AREAS DESIGNED WITH EC-25 UPRIGHT SPRINKLERS TO AN OWNER PROVIDED DESIGN DENSITY OF 0.45 GPM/S.F. OVER THE MOST DEMANDING 2000 S.F.
 - THE GARDEN CENTER DRY SYSTEM WILL BE DESIGNED TO AN OWNER PROVIDED DESIGN DENSITY OF 0.19 GPM/S.F. OVER THE MOST REMOTE 3250 S.F. OR THE ENTIRE DRY SYSTEM
 - REMOTE AREA REDUCTIONS HAVE BEEN TAKEN WHERE APPLICABLE PER NFPA 13 SEC. 11.2.3.2.3
 - NOTES:
 - ALL MATERIAL TO BE NEW AND MEET U.L. STANDARDS
 - HANGERS TO BE INSTALLED IN ACCORDANCE WITH NFPA 13 (2010) - SEE PLAN FOR HANGING REQUIREMENTS
 - DRY SYSTEM PIPE SLOPE INSTALLATION:
 - SPRINKLER MAINS TO BE 1/8" PER 10 FEET
 - SPRINKLER BRANCH LINES TO BE 1/8" PER 10 FEET
 - DRY SYSTEM CAPACITY:
 - 202 GAL
 - SYMBOLS USED ON DRAWINGS:
 - PIPE ELEVATION A.F.F.
 - PIPE ELEVATION BELOW B.O.D.
 - ROOM HAZARD CLASSIFICATION (ALL ROOMS ARE CONSIDERED LIGHT HAZARD UNLESS NOTED)
 - HYDRAULIC CALCULATION JUNCTION POINT
 - 9'-0" CEILING HEIGHT
 - SCOPE OF WORK:
 - CONSTRUCT A FIRE PUMP HOUSE PER NFPA 20 AS INDICATED ON THE PLANS PROVIDED
 - INSTALL WATER BASED PROTECTION THROUGHOUT THE FACILITY AS INDICATED ON THE PLANS PROVIDED
 - ALL AREAS OF THE BUILDING TO BE INSTALLED IN ACCORDANCE WITH THE LOCAL AUTHORITY HAVING JURISDICTION AND PER NFPA 13 (2010)

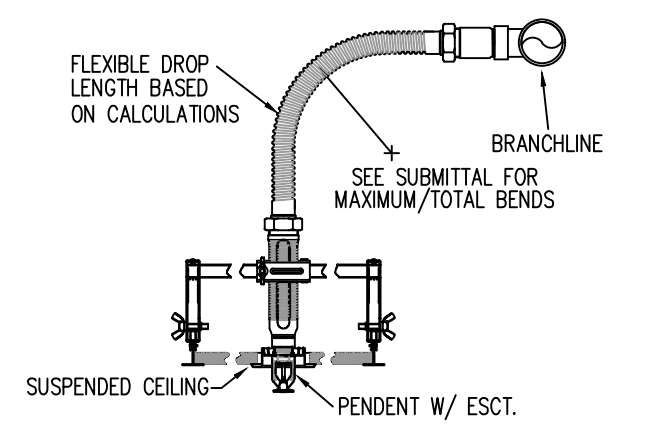


FLEXIBLE SPRINKLER DROP ASSEMBLY


INSTALLATION DETAILS

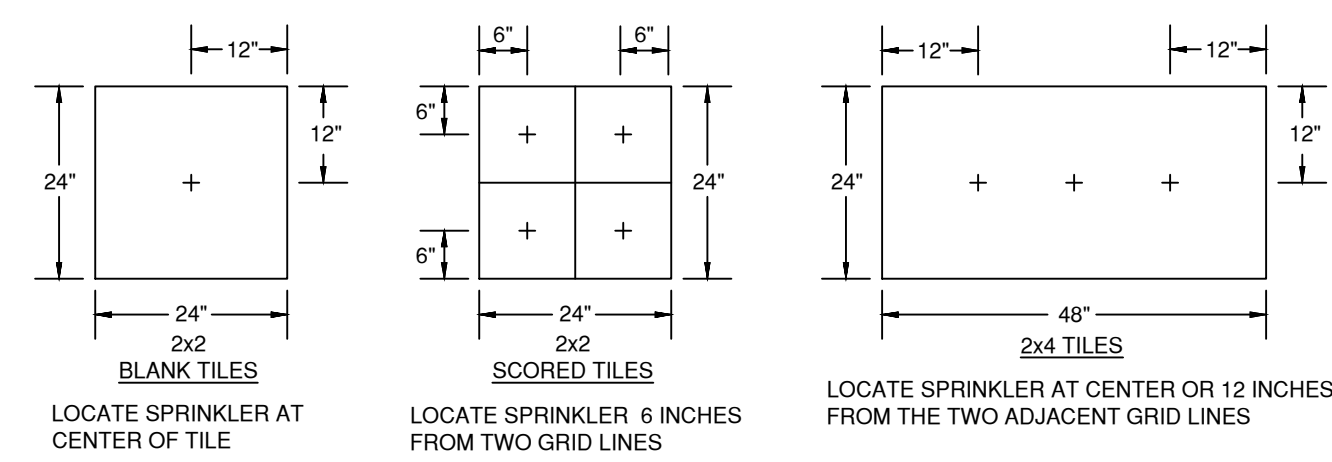

SPRINKLER PLACEMENT DETAIL

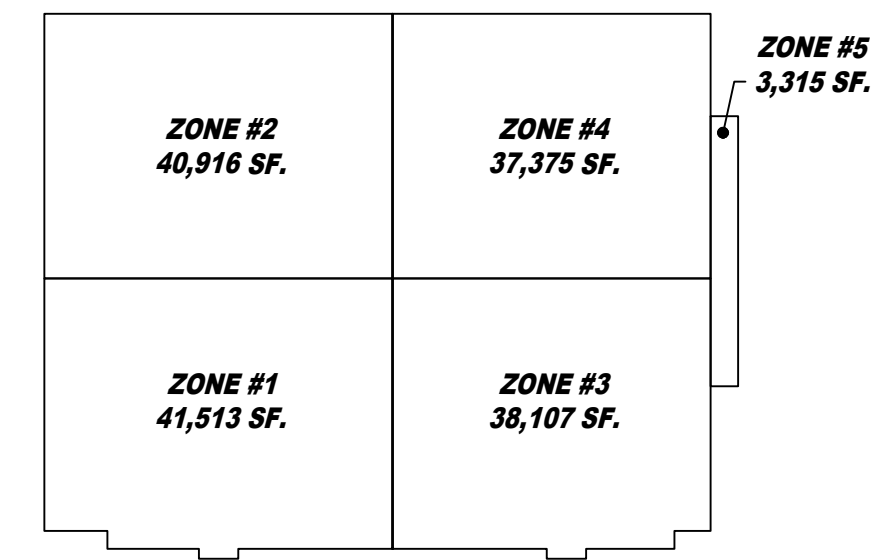


ZONE MAP

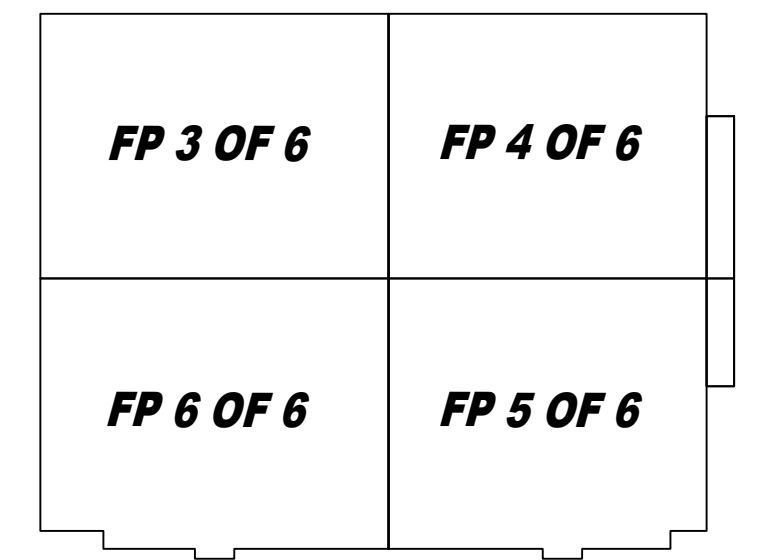


SHEET MAP

FDC DETAIL LEGEND

- FROM MAIN RISER
- GROOVED CHECK VALVE
- GROOVED DRAIN 90 W/BALL DRIP
- X 5' STORZ FDC

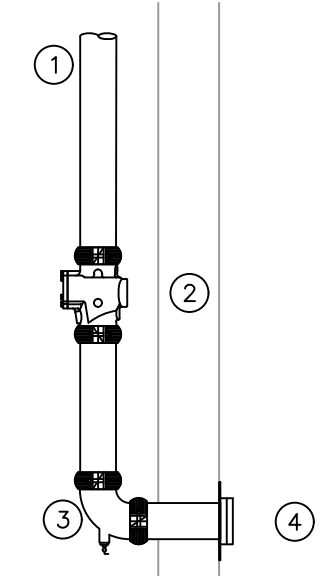


3 FDC DETAIL
SCALE: 1/2" = 1'-0"

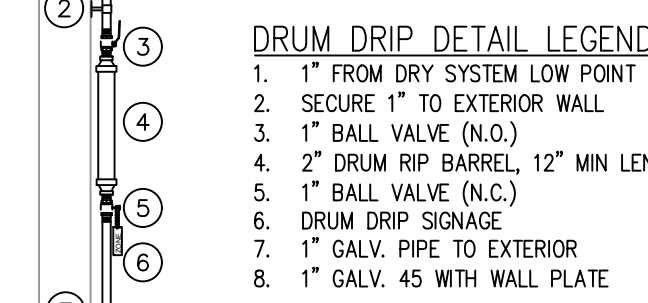

4 DRUM DRIP DETAIL
SCALE: 1/2" = 1'-0"

RISER LEGEND


- 10" WATER UNDERGROUND SERVICE FROM PUMP HOUSE (BY OTHERS) (FLUSHING & TESTING OF THE UNDERGROUND SHALL BE COMPLETED PRIOR TO THE SPRINKLER SYSTEM HOOKUP; UNDERGROUND PAPERS ARE TO BE SUPPLIED TO THE "FP" CONTRACTOR BY THE S.C.)
- 10" GROOVE FLANGE ADAPTOR
- 10" X 6" GROOVED CONCENTRIC REDUCER
- 6" GROOVED BUTTERFLY VALVE W/TAMPER (N.O.)
- 6" GROOVED 90
- 6" WELDED MANIFOLD
- 6" GROOVED COMMERCIAL RISER MANIFOLD W/ 2" TEST & DRAIN, PRESSURE GAUGE, AND FLOW SWITCH
- 4" GROOVED BUTTERFLY VALVE W/TAMPER (N.O.)
- 4" GROOVED COMMERCIAL RISER MANIFOLD W/ 2" TEST & DRAIN, PRESSURE GAUGE, AND FLOW SWITCH
- JOCKEY PUMP CONTROLLER
- PIPE STAND
- 2" GROOVED TEE
- 2" MAIN DRAIN TO EXTERIOR
- 2" GROOVED 90

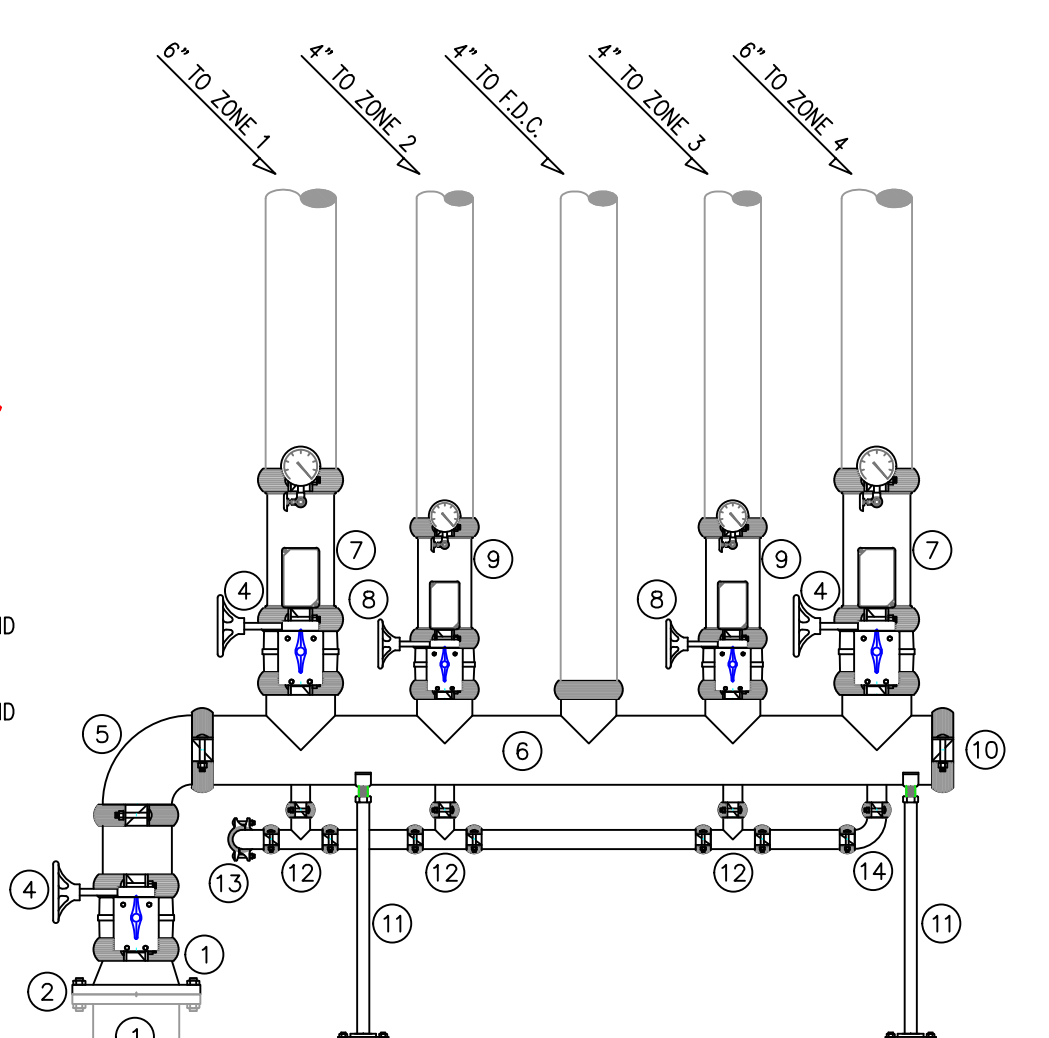

1 RISER DETAIL
SCALE: 1/2" = 1'-0"

DRY RISER LEGEND

- FED FROM ZONE #3 4" FLOAT MAIN
- 4" GROOVED 90 ELBOW
- 4" GROOVED BUTTERFLY VALVE W/ TAMPER
- 4" GROOVED DRY VALVE DPV1 W/ GALV TRIM
- TO NEW DRY SYSTEM ABOVE ADDITION
- COPPER AIR LINE TO DRY VALVE
- 2" MAIN DRAIN TO BE PIPED TO FLOOR DRAIN/ OUTSIDE. COORDINATE ON SITE.
- AIR COMPRESSOR
- PIPE STAND
- 4" DRAIN 90 WITH 1" BALL VALVE FOR LOW POINT DRAIN

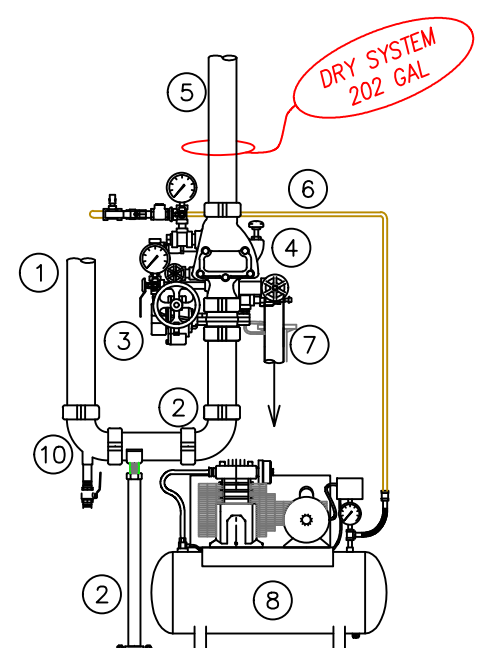

2 DRY VALVE DETAIL
SCALE: 1/2" = 1'-0"

MAXIMUM HANGER SPACING FOR PIPES PARALLEL TO JOISTS


2" & 2-1/2" PIPE EVERY 10'-0" NOT TRAPEZOID BEAM CLAMP	3" & 4" PIPE EVERY 12'-0" NOT TRAPEZOID BEAM CLAMP	6" PIPE EVERY 6'-0" TRAPEZOID BEAM CLAMP
--	--	--

MAXIMUM HANGER SPACING FOR PIPING PERPENDICULAR TO JOISTS

BEAM CLAMP NOT TRAPEZOID	BEAM CLAMP NOT TRAPEZOID (ROOF FRAMING PLAN SHADED AREA)
2" & 2-1/2" PIPE EVERY 10'-0" EVERY OTHER JOIST	2" & 2-1/2" PIPE EVERY 10'-0" EVERY OTHER JOIST
3" & 4" PIPE EVERY 6'-0" EVERY OTHER JOIST	3" & 4" PIPE EVERY 12'-0" EVERY OTHER JOIST
6" PIPE EVERY 6'-0" EVERY JOIST	6" PIPE EVERY 6'-0" EVERY JOIST

***NO TRAPEZE HANGERS ARE ANTICIPATED TO BE INSTALLED ON THIS PROJECT. PIPE SIZES SHOWN IN THIS SUBMITTAL DO NOT REQUIRE TRAPEZE MEMBERS PER HANGER SCHEDULE PROVIDED BY THE DESIGN TEAM**

HANGER DETAILS

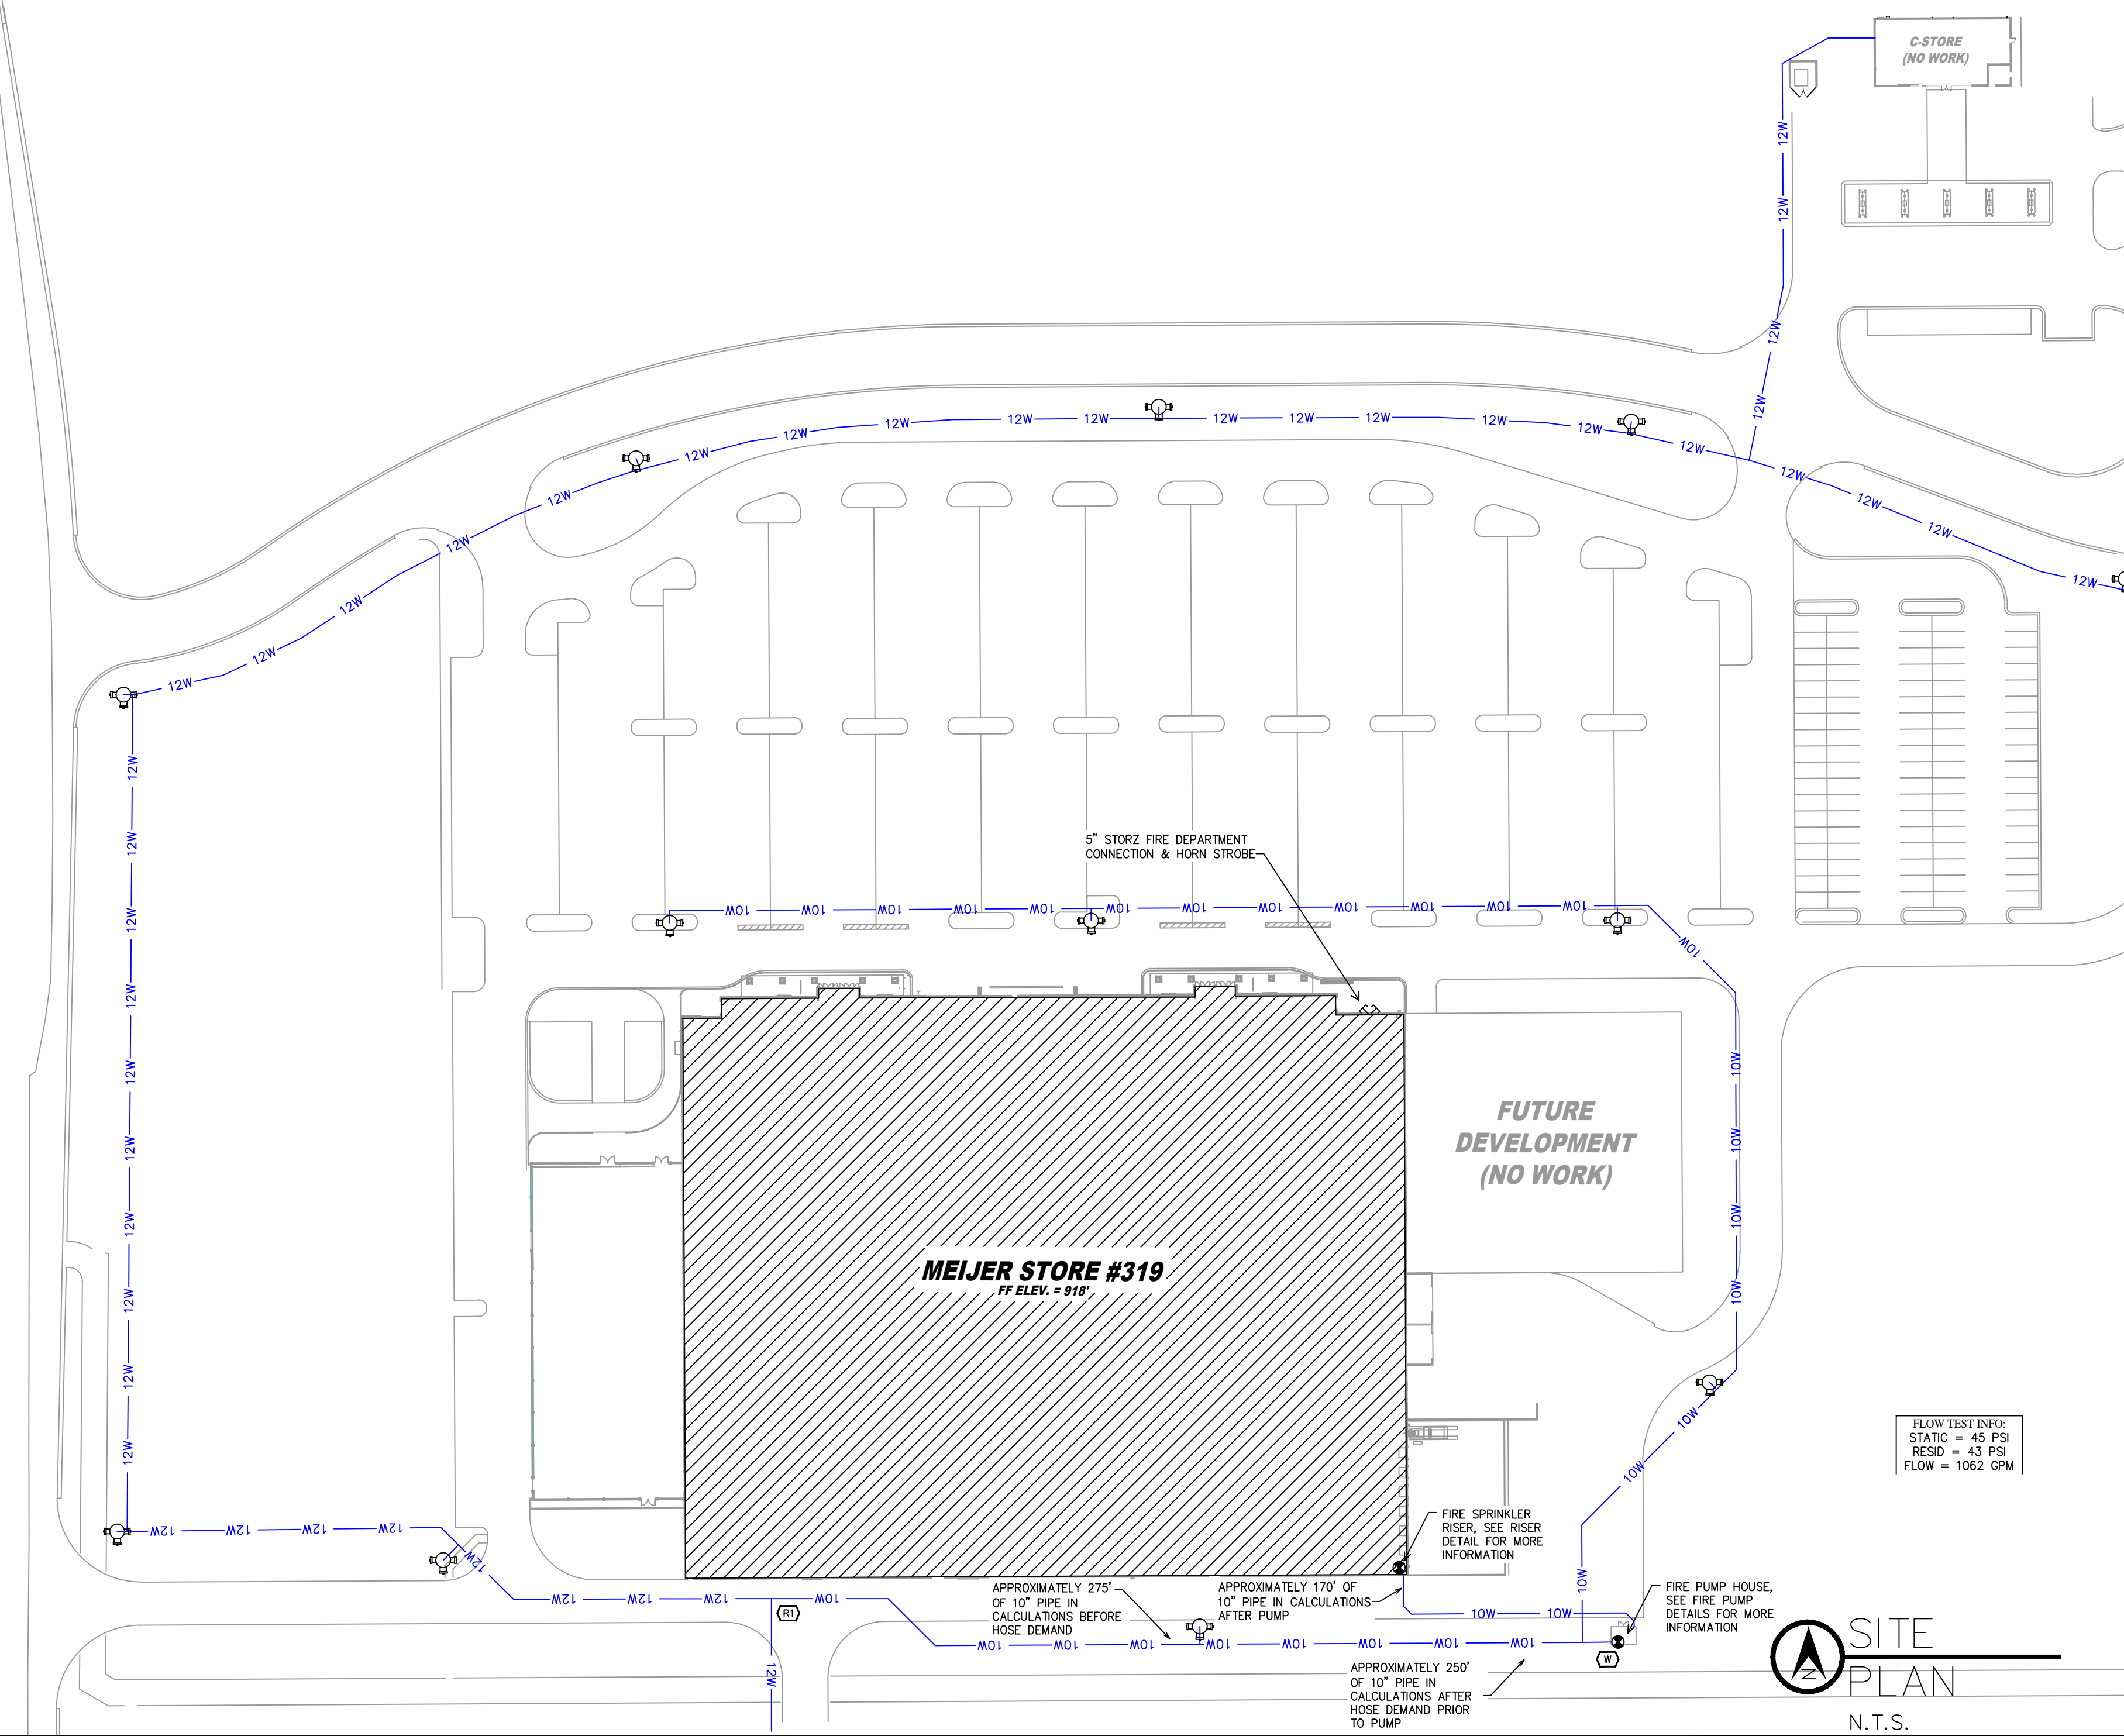

FLOW TEST INFO:
STATIC = 45 PSIG
RESID = 43 PSIG
FLOW = 1062 GPM

SITE PLAN
N.T.S.

THIS SPRINKLER WORK IS DESIGNED IN ACCORDANCE WITH N.F.P.A. PAMPHLET 13 2010 EDITION

ALARM SYSTEM BY OWNER, TO BE CENTRAL STATION PER NFPA, STATE AND LOCAL REQUIREMENTS

- WALL CLOSED OFF TO DECK
- WALL CLOSED OFF TO BOTTOM OF JOIST
- INTERIOR WALLS OPEN ABOVE CEILINGS
- ROOF AREAS WITH ADDED LOAD ALLOWANCES, SEE HANGER DETAILS FOR MORE INFORMATION

WALL / HATCH LEGEND

SPRINKLER HEAD LEGEND

SYM	CNT	POSITION	FINISH	TEMP	K	NPT	SIN	MPG	MODEL#	ESCUTCHEON
⊗	170	UPR	BRASS	214	25.20	1"	TY9128	Typ	EC-25	NONE
⊗	401	UPR	BRASS	200	14.00	3/4"	TY6137	Typ	EC-14	NONE
⊗	91	UPR	BRASS	200	8.00	3/4"	TY4131	Typ	TY-FRB	NONE
⊗	62	PEND	WHITE	200	14.00	3/4"	TY6237	Typ	EC-14	SEM-REC
⊗	27	PEND	WHITE	200	5.60	1/2"	TY323	Typ	TY-FRB	SEM-REC
⊗	63	PEND	WHITE	200	5.60	1"	V3506	VC	VS-1	SEM-REC
⊗	2	UPR	BRASS	200	14.00	3/4"	TY6137	Typ	EC-14	NONE
⊗	1	UPR	BRASS	200	8.00	3/4"	TY4131	Typ	TY-FRB	NONE
<	7	SIDE	BRASS	200	5.60	1/2"	TY3331	Typ	TY-FRB	NONE
<	824	TOTAL								

SPRINKLER HEAD LEGEND

CONTRACTOR:

REVISION

DATE	DESCRIPTION	BY



IMPORTANT
TO PREVENT FREEZING OF WATER IN WET PIPE SPRINKLER PIPING, OWNERS TO PROVIDE SUFFICIENT HEAT THROUGHOUT AREAS WHERE SPRINKLER PIPES ARE INSTALLED, UNLESS AN ANTI-FREEZE SYSTEM.

MEIJER STORE #319
225 W. SPRING MILL POINTE DR. HAMILTON COUNTY, WESTFIELD, IN 46074


SPRINKLER PLAN

NORTH

DESIGNER	JVG
SCALE	1/8" = 1'-0"
CHECK BY	RG
FILE NUMBER	
APPROVAL	STATE & LOCAL
DATE	6-15-20
DRAWING NO.	FP-1 of 6

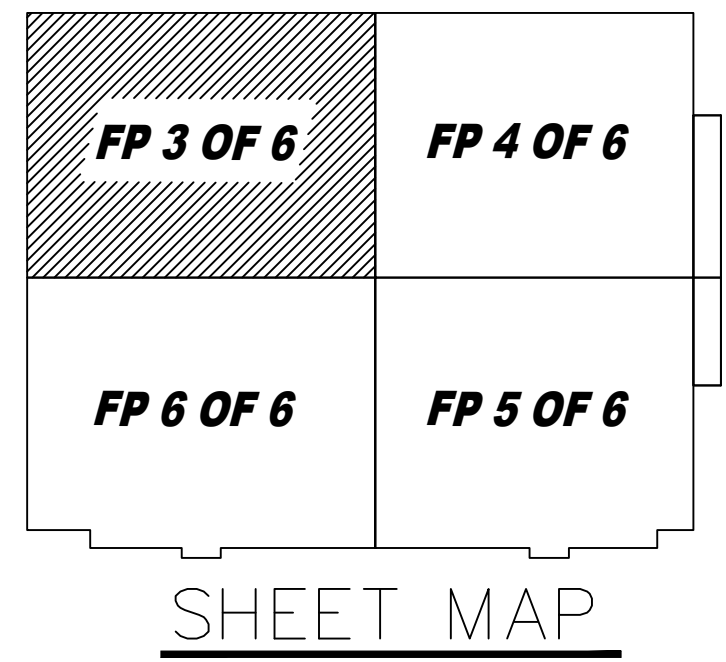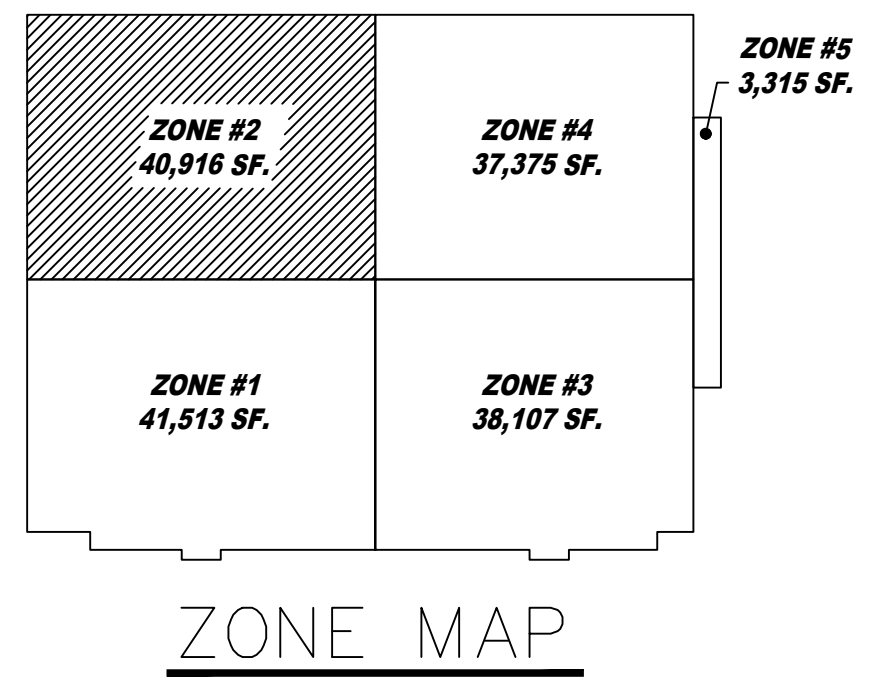

Design Area # 6 HAZARD: SPECIAL
 Zone: 2 System Type: WET
 Location: GEN. MECH. BACK ROOM
 Flowing Outlets: 15
 Density: 0.45 Remote Area: 2058
 Req. @ Inside Riser "W" (BOR):
 Flow: 939 gpm @ 57.9 psi
 Req. @ City Supply:
 Flow: 1439 gpm @ 2.7 psi
 Calculation Safety: 38.8 psi
 Includes 500 gpm Hose allowance
 SPECIFIC DESIGN CRITERIA PROVIDED
 BY DESIGN TEAM OF 0.45 GPM / S.F.
 OVER THE MOST REMOTE 2,000 S.F.
 WITH THE USE OF THE TYCO EC-25
 UPRIGHT SPRINKLER

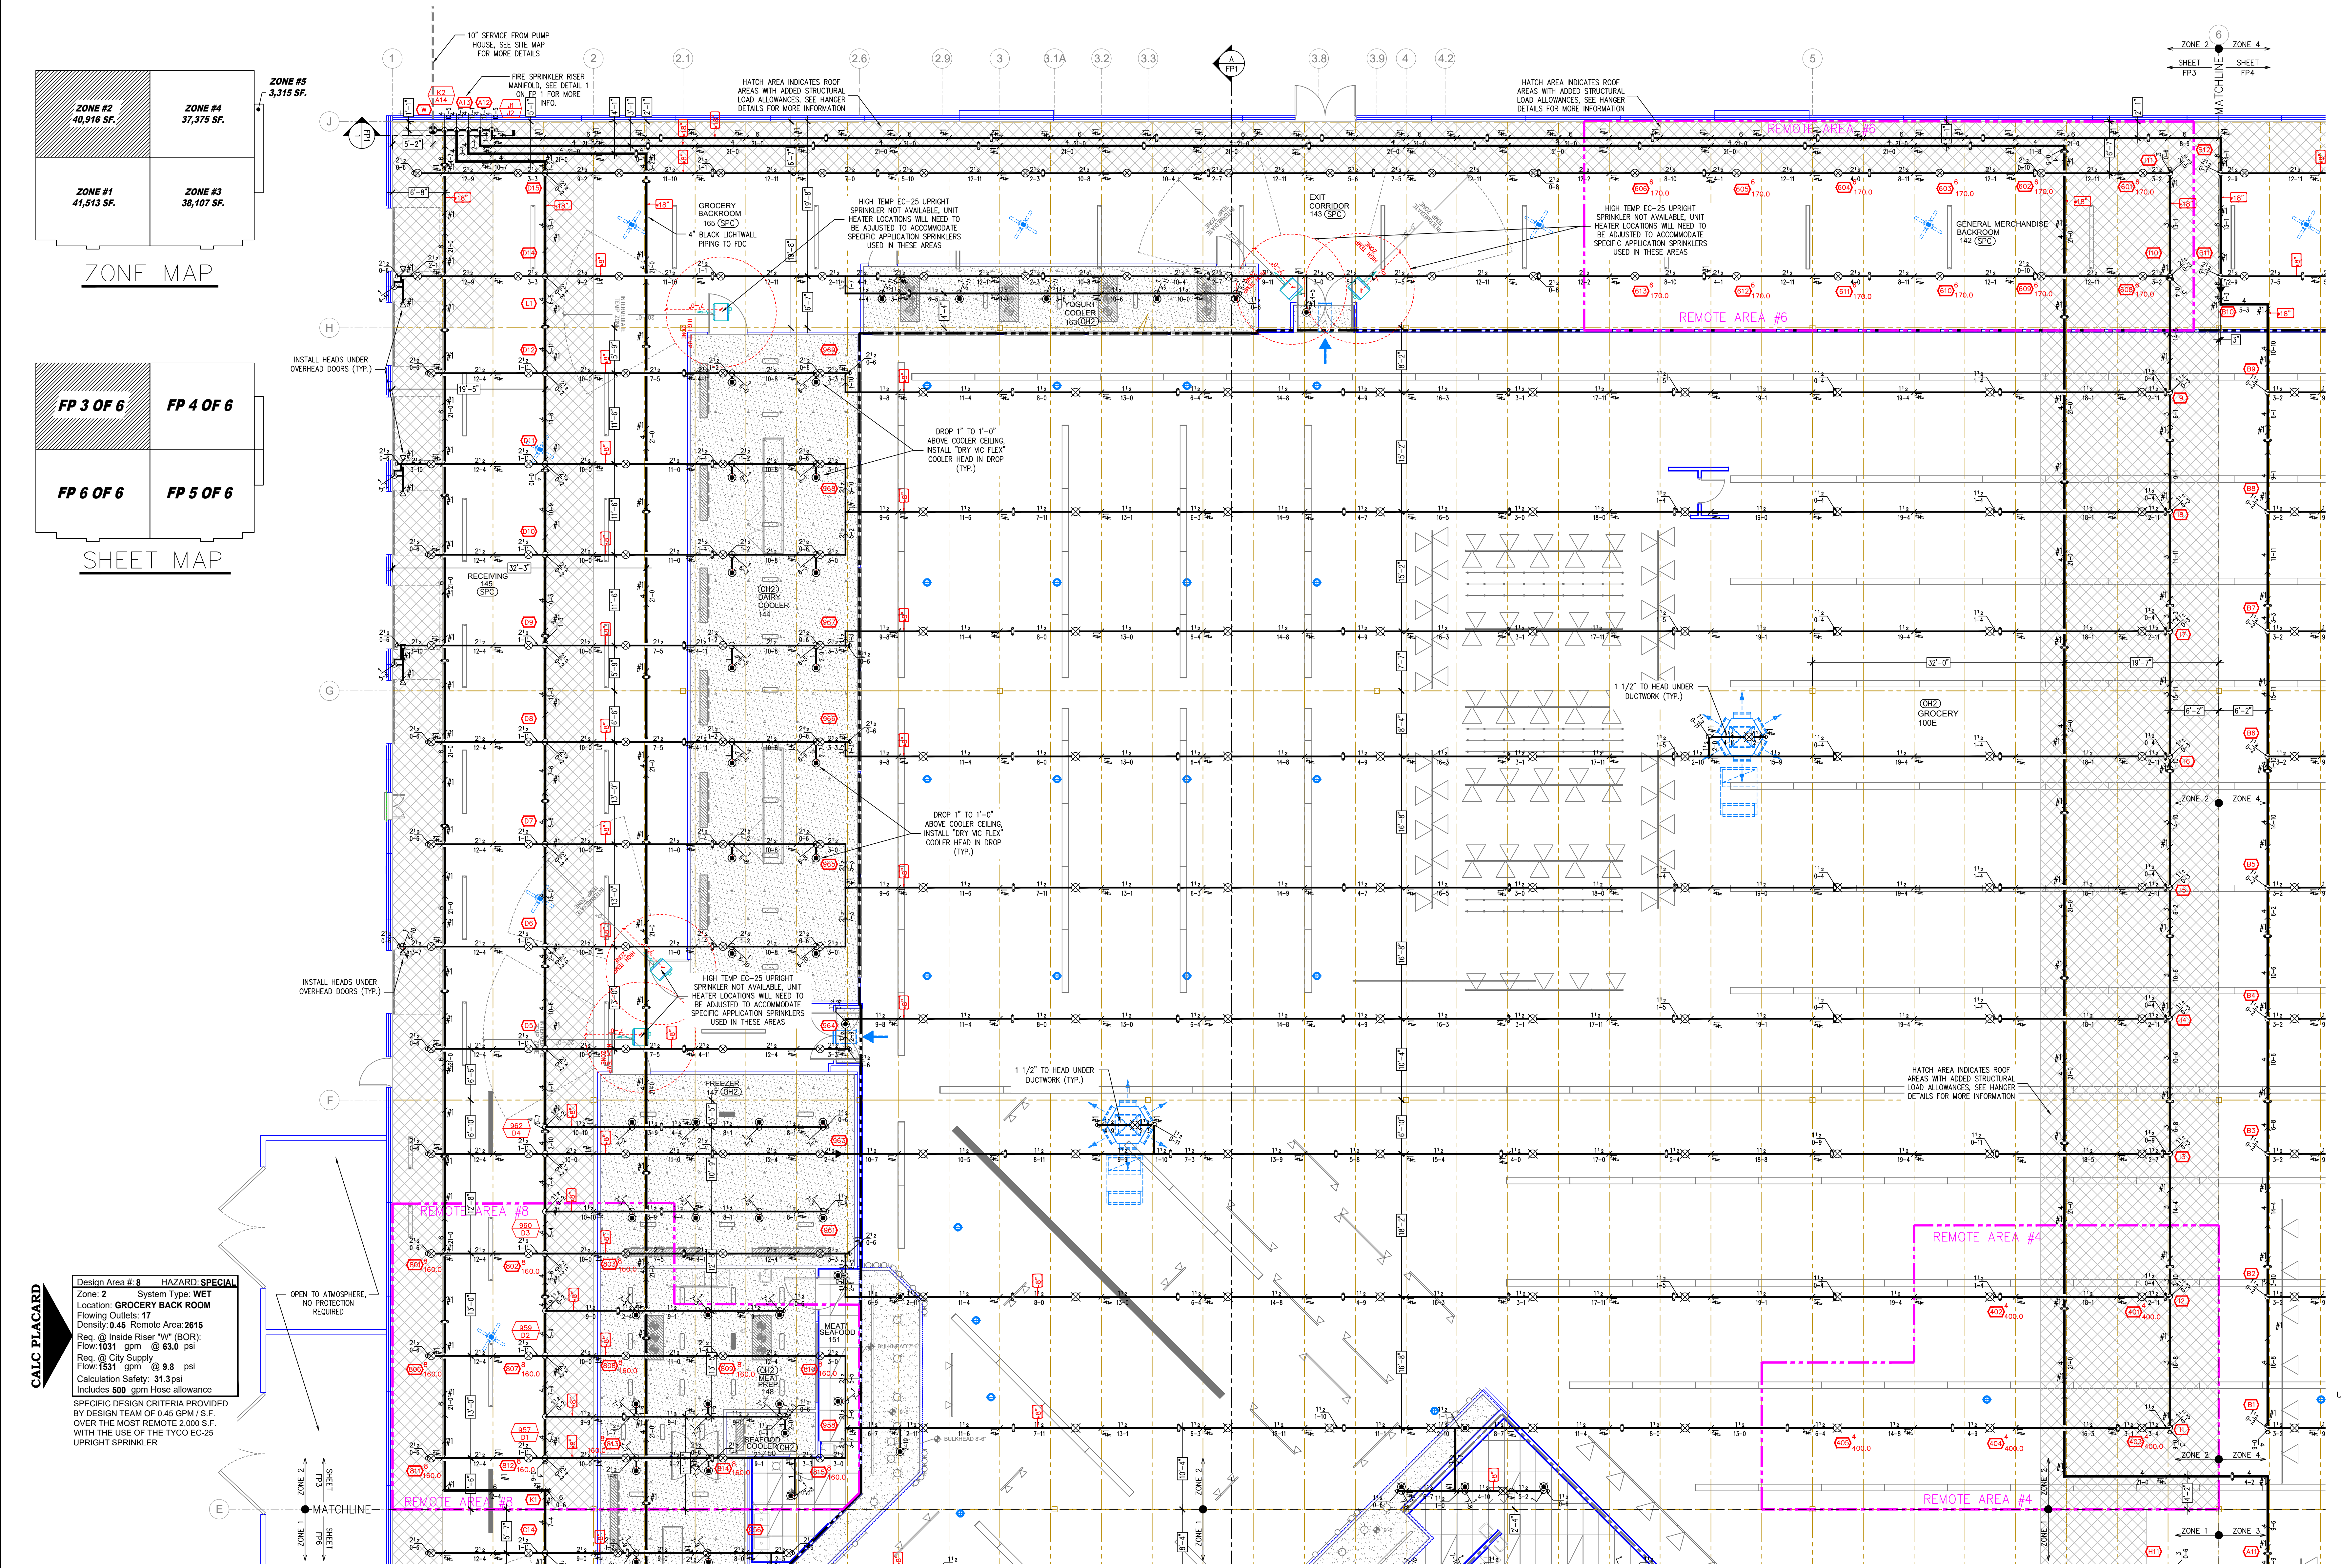

Design Area # 4 HAZARD: OH2
 Zone: 4 System Type: WET
 Location: SALES FLOOR WEST
 Flowing Outlets: 5
 Density: 0.20 Remote Area: 1758
 Req. @ Inside Riser "W" (BOR):
 Flow: 671 gpm @ 2.4 psi
 Calculation Safety: 41.8 psi
 Includes 250 gpm Hose allowance
 SPECIFIC DESIGN CRITERIA PROVIDED BY DESIGN
 TEAM OF 0.18 GPM / S.F. OVER THE MOST REMOTE
 2,500 S.F. WITH THE USE OF THE TYCO EC-14
 UPRIGHT SPRINKLER. THESE SPECIFIC APPLICATION
 SPRINKLER CUT SHEETS ONLY ALLOW FOR LIGHT,
 OH1 AND OH2 DESIGN DISCHARGES THEREFORE A
 0.20 GPM / S.F. OVER THE MOST REMOTE 1,500 S.F.
 WITH A MINIMUM OF 5 HEADS WERE CALCULATED
 WITH A MINIMUM DISCHARGE OF 80 GPM PER
 SPRINKLER FOR A MAXIMUM SPACING OF 20x20'

Design Area # 8 HAZARD: SPECIAL
 Zone: 2 System Type: WET
 Location: GROCERY BACK ROOM
 Flowing Outlets: 17
 Density: 0.45 Remote Area: 2815
 Req. @ Inside Riser "W" (BOR):
 Flow: 1031 gpm @ 63.0 psi
 Req. @ City Supply:
 Flow: 1531 gpm @ 9.8 psi
 Calculation Safety: 31.3 psi
 Includes 500 gpm Hose allowance
 SPECIFIC DESIGN CRITERIA PROVIDED
 BY DESIGN TEAM OF 0.45 GPM / S.F.
 OVER THE MOST REMOTE 2,000 S.F.
 WITH THE USE OF THE TYCO EC-25
 UPRIGHT SPRINKLER

SOUTH EAST ZONE #2 FIRE SPRINKLER PLAN
 SCALE= 1/8" : 1'-0"

THIS SPRINKLER WORK IS DESIGNED IN ACCORDANCE WITH N.F.P.A. PAMPHLET 13 2010 EDITION
 ALARM SYSTEM BY OWNER, TO BE CENTRAL STATION PER NFPA, STATE AND LOCAL REQUIREMENTS

- WALL CLOSED OFF TO DECK
- WALL CLOSED OFF TO BOTTOM OF JOIST
- INTERIOR WALLS OPEN ABOVE CEILINGS
- ROOF AREAS WITH ADDED LOAD ALLOWANCES, SEE HANGER DETAILS FOR MORE INFORMATION

SPRINKLER HEAD LEGEND

SYM	CNT	POSITION	FINISH	TEMP	K	NPT	SN	MPG	MODEL#	ESCUTCHEON
170	UPR	BRASS	214	25.20	1"	TY9128	TYco	EC-25	NONE	
401	UPR	BRASS	200	14.00	3/4"	TY6137	TYco	EC-14	NONE	
91	UPR	BRASS	200	8.00	1/2"	TY4131	TYco	TY-FRB	NONE	
62	PEND	WHITE	200	14.00	3/4"	TY6237	TYco	EC-14	SEM-REC	
27	PEND	WHITE	200	5.60	1/2"	TY323	TYco	TY-FRB	SEM-REC	
63	PEND	WHITE	200	5.60	1"	VS306	VC	VS-1	SEM-REC	
2	UPR	BRASS	200	14.00	3/4"	TY6137	TYco	EC-14	NONE	
1	UPR	BRASS	200	8.00	3/4"	TY4131	TYco	TY-FRB	NONE	
7	SIDE	BRASS	200	5.60	1/2"	TY3331	TYco	TY-FRB	NONE	
824	TOTAL									

CONTRACTOR:

REVISION


DATE	DESCRIPTION	BY

IMPORTANT
 TO PREVENT FREEZING OF WATER IN WET PIPE SPRINKLER PIPING, OWNERS TO PROVIDE SUFFICIENT HEAT THROUGHOUT AREAS WHERE SPRINKLER PIPES ARE INSTALLED, UNLESS AN ANTI-FREEZE SYSTEM.


MEIJER STORE #319
 225 W. SPRING MILL POINTE DR. HAMILTON COUNTY, WESTFIELD, IN 46074
 SPRINKLER PLAN

NORTH

DESIGNER: JVG
 SCALE: 1/8" = 1'-0"
 CHECK BY: RG
 FILE NUMBER:
 APPROVAL STATE & LOCAL:
 DATE: 6-15-20
 DRAWING NO. FP-3 OF 6

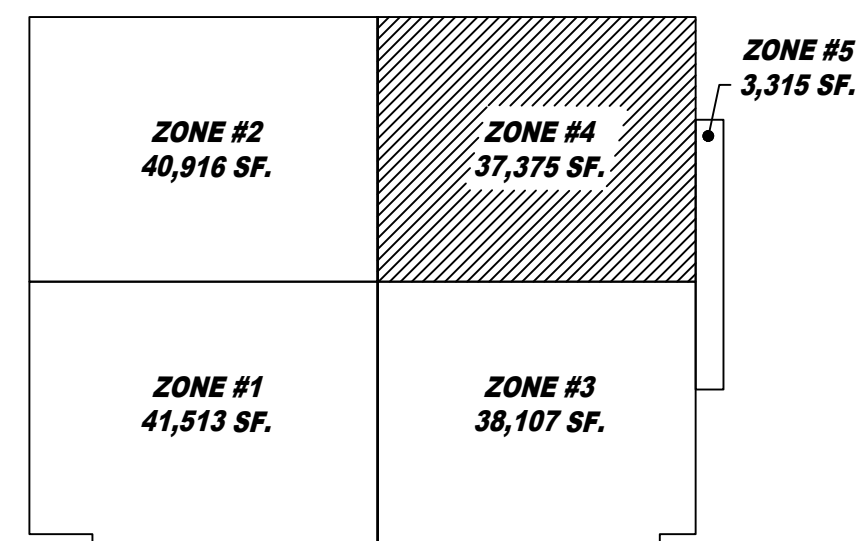

ZONE MAP

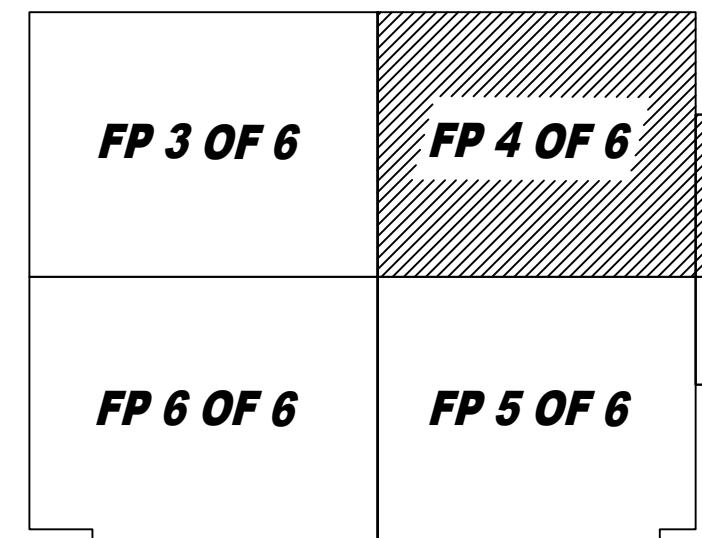

SHEET MAP



HAZARD: SPECIAL
 Zone: 4 System Type: WET
 Location: GEN. MECH. BACK ROOM
 Flowing Outlets: 15
 Density: 0.45 Remote Area: 2058
 Req. @ Inside Riser "W" (BOR):
 Flow: 1596 gpm @ 74.7 psi
 Req. @ City Supply
 Flow: 1696 gpm @ 24.3 psi
 Calculation Safety: 15.9 psi
 Includes 500 gpm Hose allowance
 SPECIFIC DESIGN CRITERIA PROVIDED
 BY DESIGN TEAM OF 0.45 GPM / S.F.
 OVER THE MOST REMOTE 2,000 S.F.
 WITH THE USE OF THE TYCO EC-25
 UPRIGHT SPRINKLER

HAZARD: OH2
 Zone: 5 System Type: DRY
 Location: GARDEN CENTER
 Flowing Outlets: 30
 Density: 0.20 Remote Area: 3180
 Req. @ Inside Riser "W" (BOR):
 Flow: 691 gpm @ 66.3 psi
 Req. @ City Supply
 Flow: 1191 gpm @ 6.9 psi
 Calculation Safety: 35.6 psi
 Includes 250 gpm Hose allowance
 SPECIFIC DESIGN CRITERIA PROVIDED
 BY DESIGN TEAM OF 0.19 GPM / S.F.
 OVER THE MOST REMOTE 3,250 S.F.

HAZARD: OH2
 Zone: 2 System Type: WET
 Location: SALES FLOOR CENTER
 Flowing Outlets: 5
 Density: 0.20 Remote Area: 1728
 Req. @ Inside Riser "W" (BOR):
 Flow: 414 gpm @ 60.6 psi
 Req. @ City Supply
 Flow: 664 gpm @ -2.7 psi
 Calculation Safety: 46.8 psi
 Includes 250 gpm Hose allowance
 SPECIFIC DESIGN CRITERIA PROVIDED BY
 DESIGN TEAM OF 0.18 GPM / S.F. OVER THE MOST REMOTE
 2,500 S.F. WITH THE USE OF THE TYCO EC-14
 UPRIGHT SPRINKLER. THESE SPECIFIC APPLICATION
 SPRINKLER CUT SHEETS ONLY ALLOW FOR LIGHT,
 OH1 AND OH2 DESIGN DISCHARGES THEREFORE A
 0.20 GPM / S.F. OVER THE MOST REMOTE 1,500 S.F.
 WITH A MINIMUM OF 5 HEADS WERE CALCULATED
 WITH A MINIMUM DISCHARGE OF 80 GPM PER
 SPRINKLER FOR A MAXIMUM SPACING OF 20x20'

SOUTH WEST ZONE #4 FIRE SPRINKLER PLAN
 SCALE = 1/8" = 1'-0"




- WALL CLOSED OFF TO DECK
- WALL CLOSED OFF TO BOTTOM OF JOIST
- INTERIOR WALLS OPEN ABOVE CEILINGS
- ROOF AREAS WITH ADDED LOAD ALLOWANCES, SEE HANGER DETAILS FOR MORE INFORMATION

SYM	QTY	POSITION	FINISH	TEMP	K	INPT	SIN	MFG.	MODEL#	ESCUTCHEON
170	UPR	BRASS	214	25.20	1"		TY9128	TYCO	EC-25	NONE
401	UPR	BRASS	200	14.00	3/4"		TY6137	TYCO	EC-14	NONE
91	UPR	BRASS	200	8.00	3/4"		TY4131	TYCO	TY-FRB	NONE
82	PEND	WHITE	200	14.00	3/4"		TY6237	TYCO	EC-14	SEMI-REC
27	PEND	WHITE	200	5.60	1/2"		TY323	TYCO	TY-FRB	SEMI-REC
63	PEND	WHITE	200	5.60	1"		V3506	VC	VS-1	SEMI-REC
2	UPR	BRASS	200	14.00	3/4"		TY6137	TYCO	EC-14	NONE
1	UPR	BRASS	200	8.00	3/4"		TY4131	TYCO	TY-FRB	NONE
7	NOSE	BRASS	200	5.60	1/2"		TY3331	TYCO	TY-FRB	NONE
824	TOTAL									

CONTRACTOR:
 ADDRESS:
 REVISION
 DATE DESCRIPTION BY
 IMPORTANT
 TO PREVENT FREEZING OF WATER IN WET PIPE SPRINKLER PIPING,
 OWNERS TO PROVIDE SUFFICIENT HEAT THROUGHOUT AREAS WHERE
 SPRINKLER PIPES ARE INSTALLED, UNLESS AN ANTI-FREEZE SYSTEM.

MEIJER STORE #319
 225 W. SPRING MILL POINTE DR. HAMILTON COUNTY, WESTFIELD, IN 46074
 SPRINKLER PLAN

NORTH
 DESIGNER: JVG
 SCALE: 1/8" = 1'-0"
 CHECK BY: RC
 FILE NUMBER:
 APPROVAL: STATE & LOCAL
 DATE: 6-15-20
 DRAWING NO. FP-4 OF 6

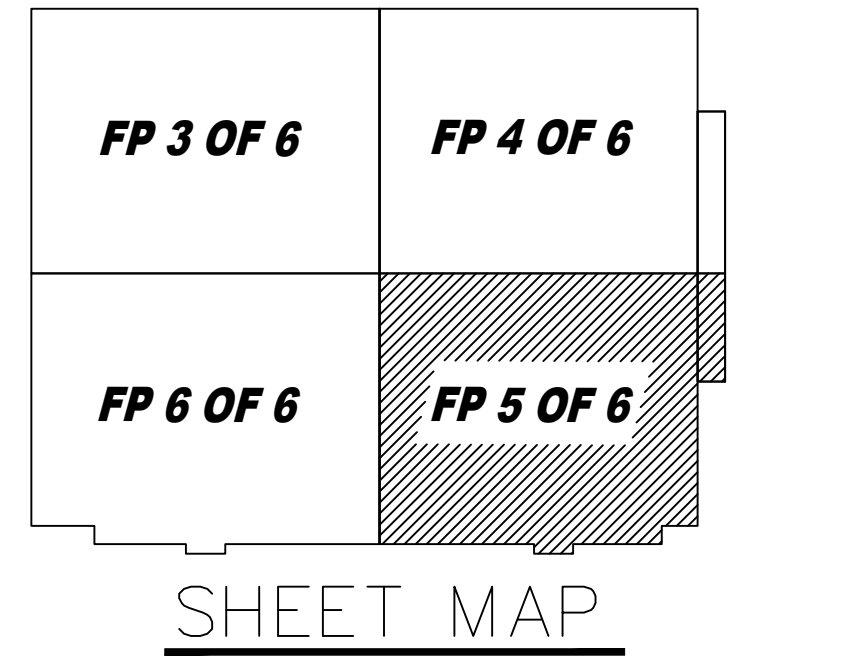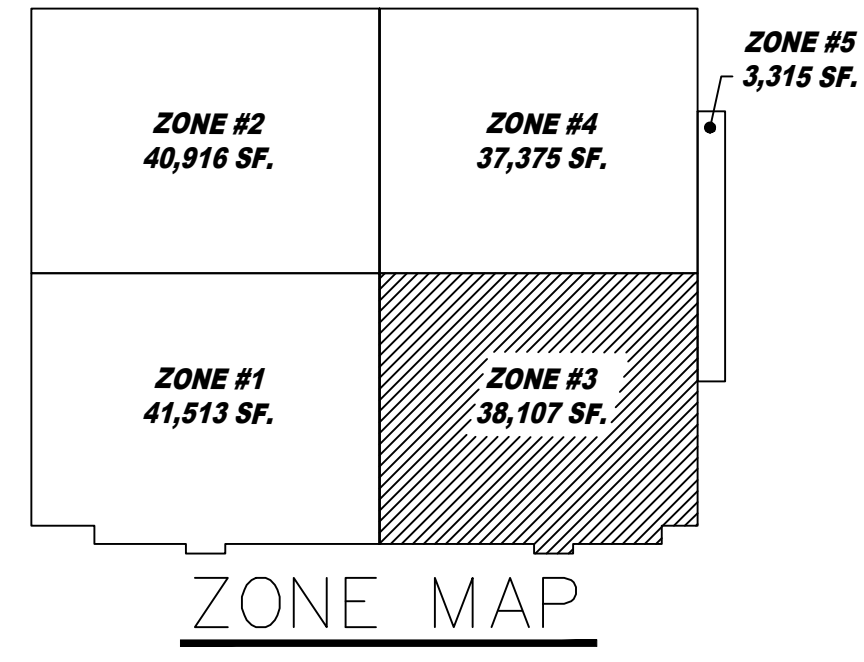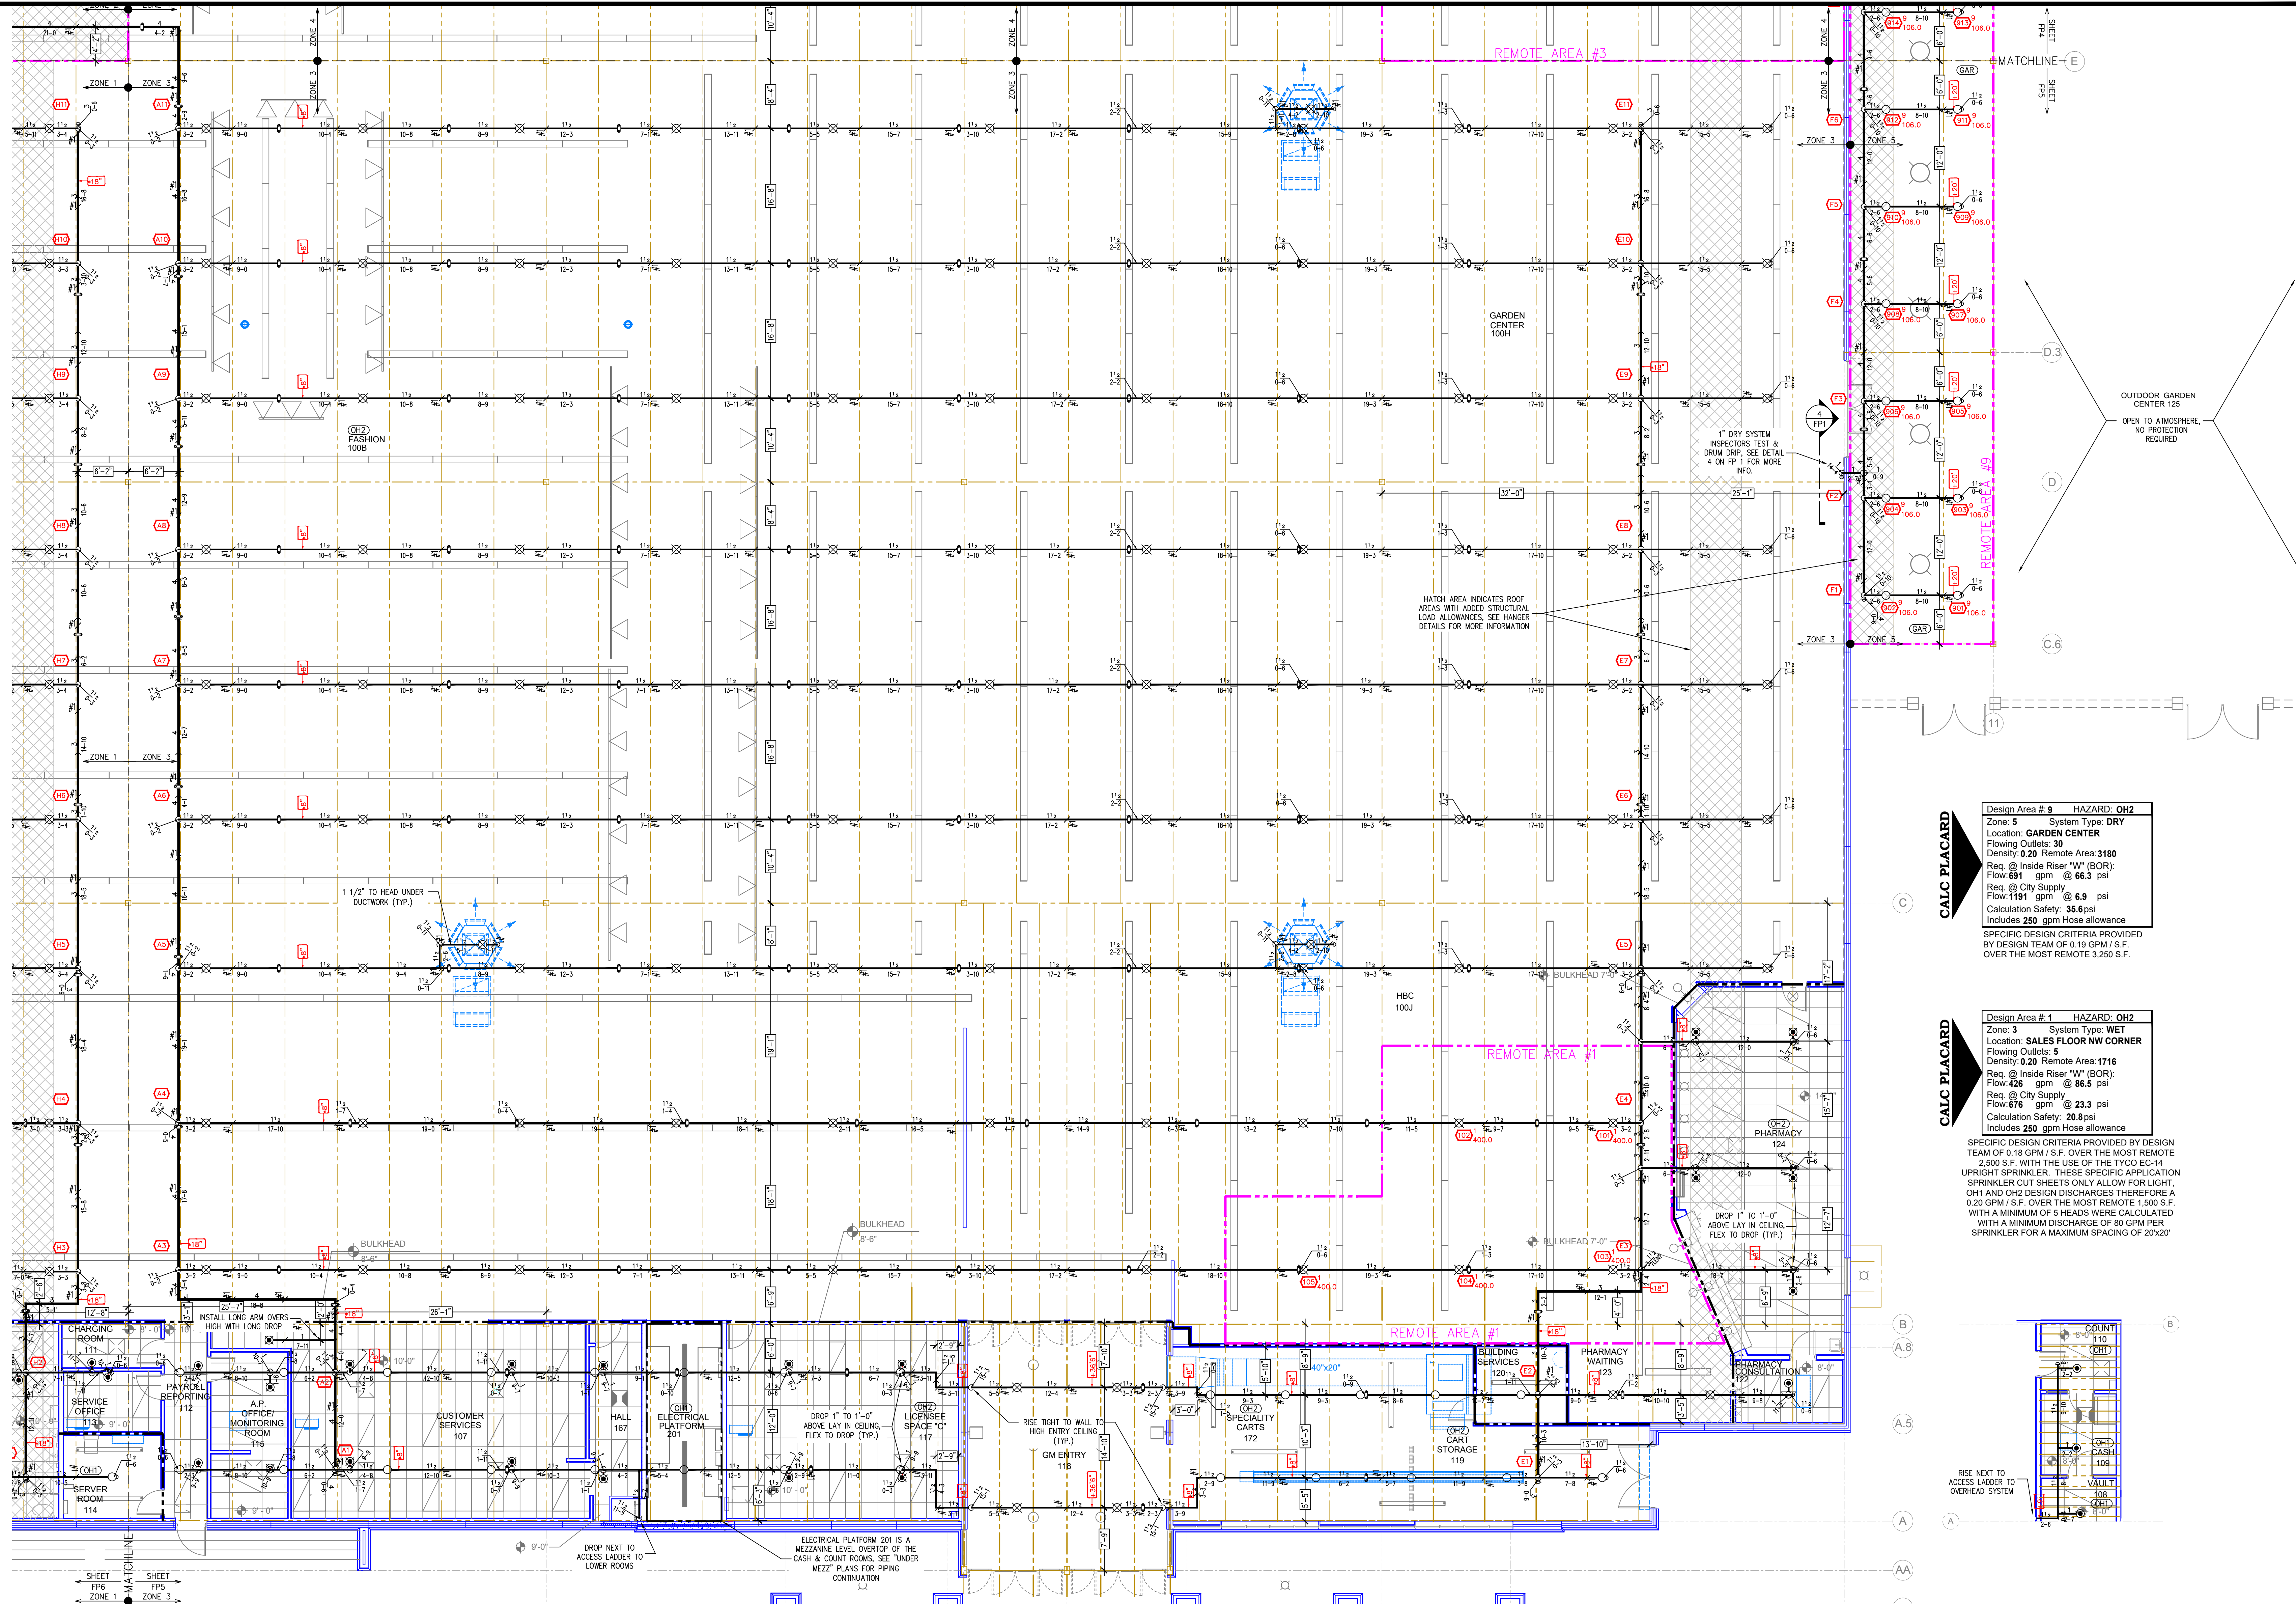

HAZARD: OH2
Zone: 5 System Type: DRY
 Location: GARDEN CENTER
 Flowing Outlets: 30
 Density: 0.20 Remote Area: 3180
 Req. @ Inside Riser "W" (BOR):
 Flow: 691 gpm @ 66.3 psi
 Req. @ City Supply:
 Flow: 191 gpm @ 6.9 psi
 Calculation Safety: 35.6 psi
 Includes 250 gpm Hose allowance
 SPECIFIC DESIGN CRITERIA PROVIDED BY DESIGN TEAM OF 0.18 GPM / S.F. OVER THE MOST REMOTE 3,250 S.F.

HAZARD: OH2
Zone: 3 System Type: WET
 Location: SALES FLOOR NW CORNER
 Flowing Outlets: 5
 Density: 0.20 Remote Area: 1716
 Req. @ Inside Riser "W" (BOR):
 Flow: 426 gpm @ 86.5 psi
 Req. @ City Supply:
 Flow: 676 gpm @ 23.3 psi
 Calculation Safety: 20.8 psi
 Includes 250 gpm Hose allowance
 SPECIFIC DESIGN CRITERIA PROVIDED BY DESIGN TEAM OF 0.18 GPM / S.F. OVER THE MOST REMOTE 2,500 S.F. WITH THE USE OF THE TYCO EC-14 UPRIGHT SPRINKLER. THESE SPECIFIC APPLICATION SPRINKLER CUT SHEETS ONLY ALLOW FOR LIGHT, OH1 AND OH2 DESIGN DISCHARGES THEREFORE A 0.20 GPM / S.F. OVER THE MOST REMOTE 1,500 S.F. WITH A MINIMUM DISCHARGE OF 80 GPM PER SPRINKLER FOR A MAXIMUM SPACING OF 20'x20'

NORTH WEST ZONE #3 FIRE SPRINKLER PLAN
 SCALE= 1/8" : 1'-0"

UNDER MEZZ. FIRE SPRINKLER PLAN
 SCALE= 1/8" : 1'-0"

THIS SPRINKLER WORK IS DESIGNED IN ACCORDANCE WITH N.F.P.A. PAMPHLET 13 2010 EDITION
 ALARM SYSTEM BY OWNER, TO BE CENTRAL STATION PER NFPA, STATE AND LOCAL REQUIREMENTS

- WALL CLOSED OFF TO DECK
- WALL CLOSED OFF TO BOTTOM OF JOIST
- INTERIOR WALLS OPEN ABOVE CEILINGS
- ROOF AREAS WITH ADDED LOAD ALLOWANCES, SEE HANGER DETAILS FOR MORE INFORMATION

SYM	CNT	POSITION	FINISH	TEMP	K	NPT	SIN	MPG	MODEL#	ESCUTCHEON
170	UPR	BRASS	214	25.20	1"	TY9128	TY9128	TY9128	EC-25	NONE
401	UPR	BRASS	200	14.00	3/4"	TY6137	TY6137	TY6137	EC-14	NONE
91	UPR	BRASS	200	8.00	1/2"	TY4131	TY4131	TY4131	TY-FRB	NONE
62	PEND	WHITE	200	14.00	3/4"	TY6237	TY6237	TY6237	EC-14	SEM-REC
27	PEND	WHITE	200	5.60	1/2"	TY3231	TY3231	TY3231	TY-FRB	SEM-REC
63	PEND	WHITE	200	5.60	1"	V3506	V3506	V3506	VS-1	SEM-REC
2	UPR	BRASS	200	14.00	3/4"	TY6137	TY6137	TY6137	EC-14	NONE
1	UPR	BRASS	200	8.00	3/4"	TY4131	TY4131	TY4131	TY-FRB	NONE
7	SIDE	BRASS	200	5.60	1/2"	TY3331	TY3331	TY3331	TY-FRB	NONE
824	TOTAL									

CONTRACTOR: _____
 ADDRESS: _____
 DATE: _____

REVISION	DESCRIPTION	BY




IMPORTANT
 TO PREVENT FREEZING OF WATER IN WET PIPE SPRINKLER PIPING, OWNERS TO PROVIDE SUFFICIENT HEAT THROUGHOUT AREAS WHERE SPRINKLER PIPES ARE INSTALLED, UNLESS AN ANTI-FREEZE SYSTEM.

MEIJER STORE #319
 225 W. SPRING MILL POINTE DR. HAMILTON COUNTY, WESTFIELD, IN 46074

SPRINKLER PLAN

NORTH

DESIGNER: JVG
 SCALE: 1/8" = 1'-0"
 CHECK BY: RG
 FILE NUMBER:
 APPROVAL STATE & LOCAL:
 DATE: 6-15-20
 DRAWING NO. FP-5 OF 6

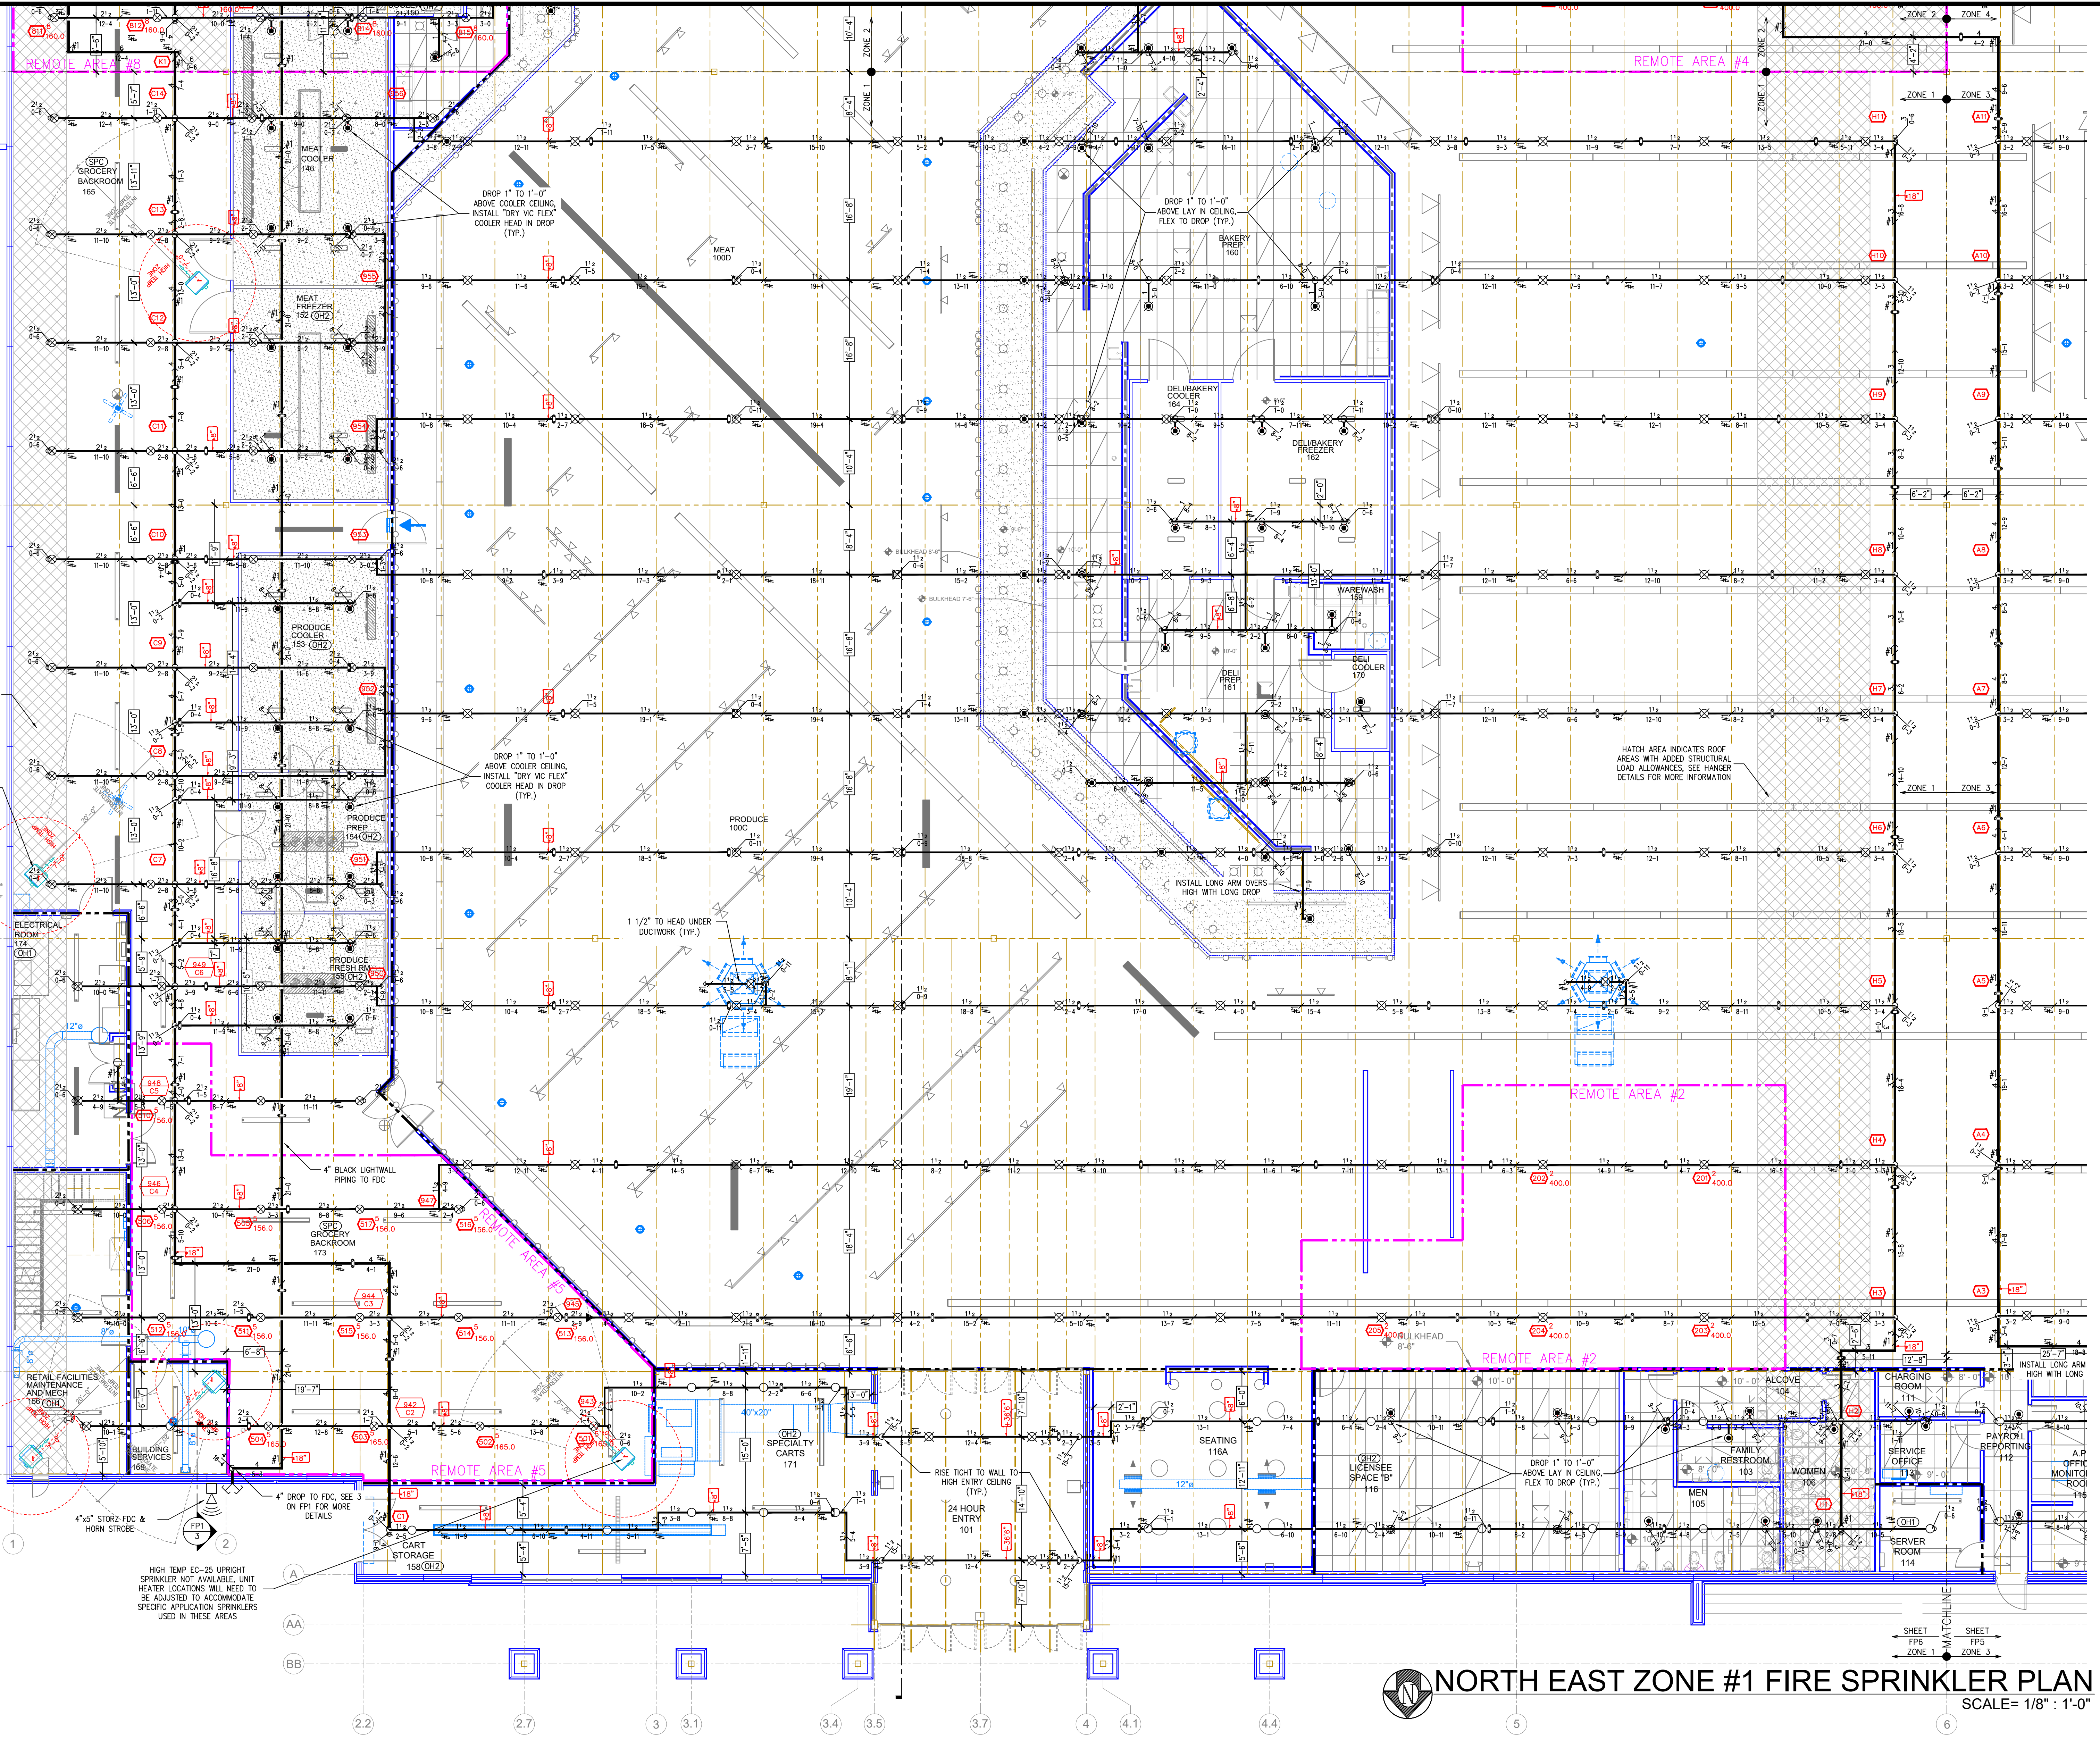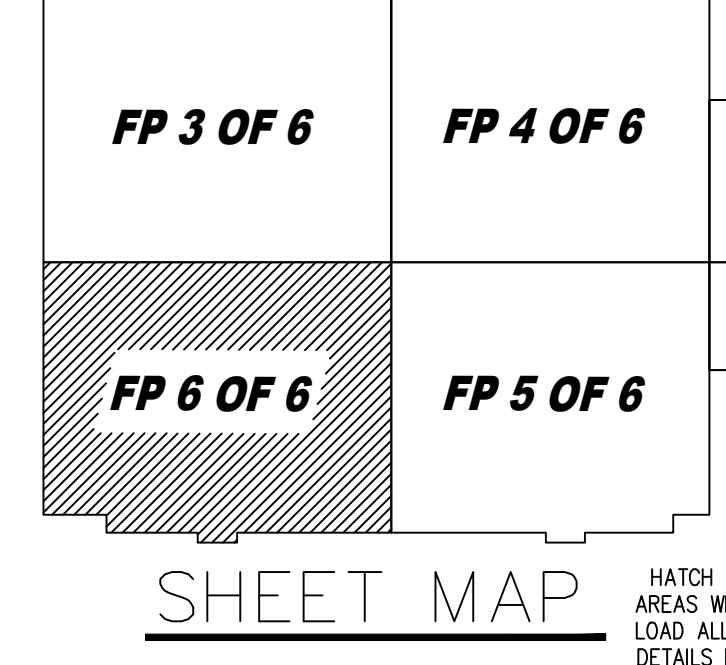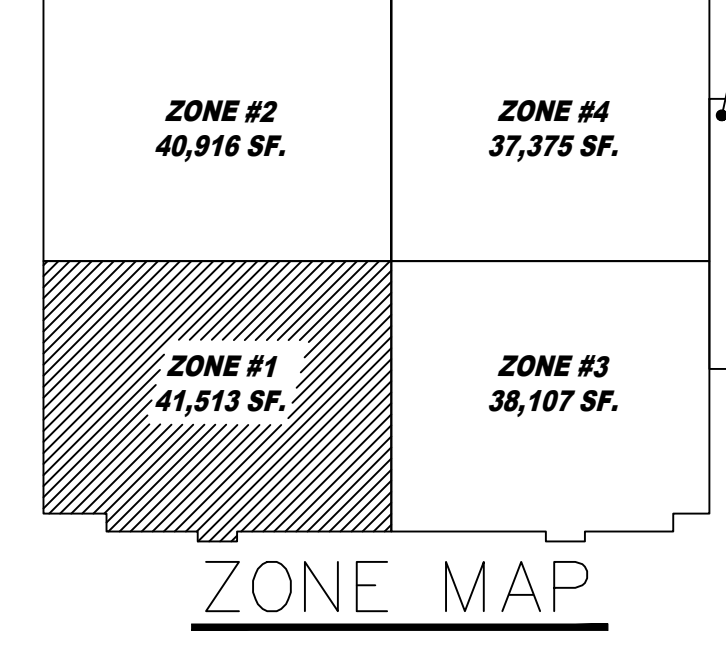

Design Area # 5 HAZARD: SPECIAL
 Zone: 1 System Type: WET
 Location: STOCK ROOM NORTH
 Flowing Outlets: 18
 Density: 0.45 Remote Area: 2060
 Req. @ Inside Riser "W" (BOR):
 Flow: 1170 gpm @ 32.9 psi
 Req. @ City Supply:
 Flow: 1670 gpm @ 31.9 psi
 Calculation Safety: 8.8 psi
 Includes 500 gpm Hose allowance
 SPECIFIC DESIGN CRITERIA PROVIDED BY DESIGN TEAM OF 0.45 GPM / S.F. OVER THE MOST REMOTE 2,000 S.F. WITH THE USE OF THE TYCO EC-25 UPRIGHT SPRINKLER

Design Area # 2 HAZARD: OH2
 Zone: 1 System Type: WET
 Location: SALES FLOOR NORTH
 Flowing Outlets: 6
 Density: 0.20 Remote Area: 1616
 Req. @ Inside Riser "W" (BOR):
 Flow: 420 gpm @ 71.3 psi
 Req. @ City Supply:
 Flow: 670 gpm @ 7.9 psi
 Calculation Safety: 36.3 psi
 Includes 250 gpm Hose allowance

SPECIFIC DESIGN CRITERIA PROVIDED BY DESIGN TEAM OF 0.18 GPM / S.F. OVER THE MOST REMOTE 2,500 S.F. WITH THE USE OF THE TYCO EC-14 UPRIGHT SPRINKLER. THESE SPECIFIC APPLICATION SPRINKLER CUT SHEETS ONLY ALLOW FOR LIGHT, OH1 AND OH2 DESIGN DISCHARGES THEREFORE A 0.20 GPM / S.F. OVER THE MOST REMOTE 1,600 S.F. WITH A MINIMUM OF 5 HEADS WERE CALCULATED WITH A MINIMUM DISCHARGE OF 80 GPM PER SPRINKLER FOR A MAXIMUM SPACING OF 20'x20'

THIS SPRINKLER WORK IS DESIGNED IN ACCORDANCE WITH N.F.P.A. PAMPHLET 13 2010 EDITION
 ALARM SYSTEM BY OWNER, TO BE CENTRAL STATION PER NFPA, STATE AND LOCAL REQUIREMENTS

- WALL CLOSED OFF TO DECK
- WALL CLOSED OFF TO BOTTOM OF JOIST
- INTERIOR WALLS OPEN ABOVE CEILINGS
- ROOF AREAS WITH ADDED LOAD ALLOWANCES, SEE HANGER DETAILS FOR MORE INFORMATION

SYM	CNT	POSITION	FINISH	TEMP	K	NPT	SIN	MPG	MODEL#	ESCUTCHEON
170	UPR	BRASS	214	25.20	1"	TY9128	TY9128	TY9128	EC-25	NONE
401	UPR	BRASS	200	14.00	3/4"	TY6137	TY6137	TY6137	EC-14	NONE
91	UPR	BRASS	200	8.00	1/2"	TY4131	TY4131	TY4131	TY-FRB	NONE
62	PEND	WHITE	200	14.00	3/4"	TY6237	TY6237	TY6237	EC-14	SEM-REC
27	PEND	WHITE	200	5.60	1/2"	TY323	TY323	TY323	TY-FRB	SEM-REC
63	PEND	WHITE	200	5.60	1"	VS306	VS306	VS306	VS-1	SEM-REC
2	UPR	BRASS	200	14.00	3/4"	TY6137	TY6137	TY6137	EC-14	NONE
1	UPR	BRASS	200	8.00	1/2"	TY4131	TY4131	TY4131	TY-FRB	NONE
7	SIDE	BRASS	200	5.90	1/2"	TY331	TY331	TY331	TY-FRB	NONE
824	TOTAL									

CONTRACTOR:

ADDRESS:

DATE	REVISION	DESCRIPTION	BY

IMPORTANT
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MEIJER STORE #319
 225 W. SPRING MILL POINTE DR. HAMILTON COUNTY, WESTFLED, IN 46074
 SPRINKLER PLAN

NORTH

DESIGNER: JVG
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 DRAWING NO. FP-6 OF 6

NORTH EAST ZONE #1 FIRE SPRINKLER PLAN
 SCALE = 1/8" = 1'-0"