

SPRINKLER SPACING

- A SINGLE PENDENT SPRINKLER MAY BE SPACED AT A MAXIMUM OF 18'x18'(324 SQ. FT.) OR UP TO 10'OFF A
- WALL. TWO OR MORE HEADS IN A COMPARTMENT SHALL BE SPACED AT A MAXIMUM OF 16'x16'(256 SQ. FT.) OR UP TO 8' OFF A WALL. HEADS ON LOWER LEVEL MAY BE SPACED 18'x18'
- SPRINKLERS SHALL BE MEASURED AT PERPENDICULAR ANGLES TO WALLS AND ALONG THE SLOPES OF CEILINGS.

SUBMITTAL

	Nominal Pipe Size (in.)									
	3⁄4	1	11⁄4	11/2	2	21/2	3	4	6	8
Steel Pipe except threaded lightwall	N/A	12-0	12-0	15-0	15-0	15-0	15-0	15-0	15-0	15-0
Threaded lightwall steel pipe	N/A	12-0	12-0	15-0	15-0	15-0	15-0	N/A	N/A	N/A
Copper tube	8-0	8-0	10-0	10-0	12-0	12-0	12-0	15-0	15-0	15-0
CPVC	5-6	6-0	6-6	7-0	8-0	9-0	10-0	N/A	N/A	N/A

PROJECT SQUARE FOOTAGES

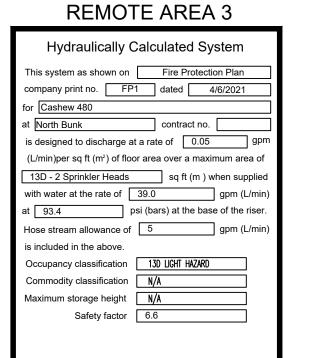
LOWER LEVEL = 3477 S.F. $\begin{array}{rcl} \text{MAIN LEVEL} &=& 5076 \text{ S.F.} \\ \text{UPPER LEVEL} &=& 1159 \text{ S.F.} \\ \text{TOTAL} &=& 9712 \text{ S.F.} \end{array}$

REMOTE AREA 1

Hydraulically Calculated System
This system as shown on Fire Protection Plan
company print no. FP1 dated 4/6/2021
for Cashew 480
at North Suite contract no.
is designed to discharge at a rate of 0.05 gpm
(L/min)per sq ft (m^2) of floor area over a maximum area of
13D - 2 Sprinkler Heads sq ft (m) when supplied
with water at the rate of 32.4 gpm (L/min)
at 87.6 psi (bars) at the base of the riser.
Hose stream allowance of 5 gpm (L/min)
is included in the above.
Occupancy classification 13D LIGHT HAZARD
Commodity classification N/A
Maximum storage height N/A
Safety factor 12.4

REMOTE AREA 2

Hydraulically Calculated System
This system as shown on Fire Protection Plan
company print no. FP1 dated 4/6/2021
for Cashew 480
at North Bunk Bath contract no.
is designed to discharge at a rate of 0.05 gpm
(L/min)per sq ft (m^2) of floor area over a maximum area of
13D - Most Demanding Room sq ft (m) when supplied
with water at the rate of 31.2 gpm (L/min)
at 69.4 psi (bars) at the base of the riser.
Hose stream allowance of 5 gpm (L/min)
is included in the above.
Occupancy classification 13D LIGHT HAZARD
Commodity classification N/A
Maximum storage height N/A
Safety factor 30.6



REMOTE AREA 5


Hydraulically Calculate
This system as shown on Fire P
company print no. FP1 dated
for Cashew 480
at Guest Bath contra
is designed to discharge at a rate of [
(L/min)per sq ft (m²) of floor area over a
13D - 2 Sprinkler Heads sq ft
with water at the rate of 31.3
at 67.5 psi (bars) at t
Hose stream allowance of 5
is included in the above.
Occupancy classification 13D LIGHT
Commodity classification N/A
Maximum storage height N/A
Safety factor 32.5


PIPE	VOLUMES:
(CPVC)	

TOTAL PIPE FOOTAGE AND CAPACITY: **∛** = 434' (13.53 GAL) 1" = 444' (21.96 GAL)


ADD 10% FOR DROPS AND PIPE SIZE

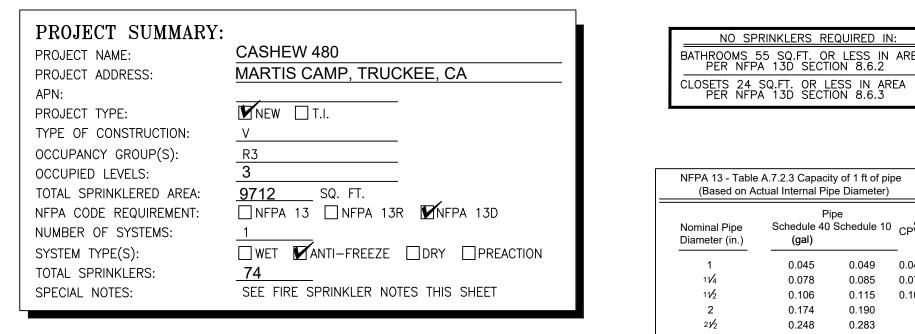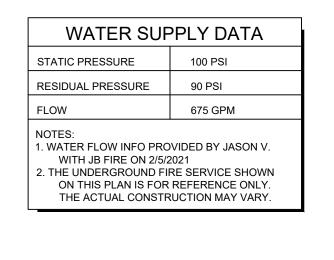
DISCREPANCIES TOTAL VOLUME: ± 39.03 GALLONS







<u>SPRINKLER HEAT</u>	ZONES: ORDINARY	INTERMEDIATE
HEAT SOURCE:	TEMP SPRINKLER	
SIDE OF OPEN OR RECESSED FIRE PLACE	36"	12"
FRONT OF RECESSED FIRE PLACE	60"	36"
COAL OR WOOD BURNING STOVE	42"	12"
RANGE/OVEN, HOT AIR FLUES & UNINSULATED HEAT DUCT	18"	9"
UNINSULATED HOT WATER PIPES & 250-499 WATT LIGHTS	12"	6"
SIDE OF CEILING OR WALL MOUNTED HOT AIR DIFFUSERS	24"	12"
FRONT OF WALL MOUNTED HOT AIR DIFFUSEF HOT WATER HEATER, FURNACE, LIGHT FIXTUR 0-250 WATT		18" 3"

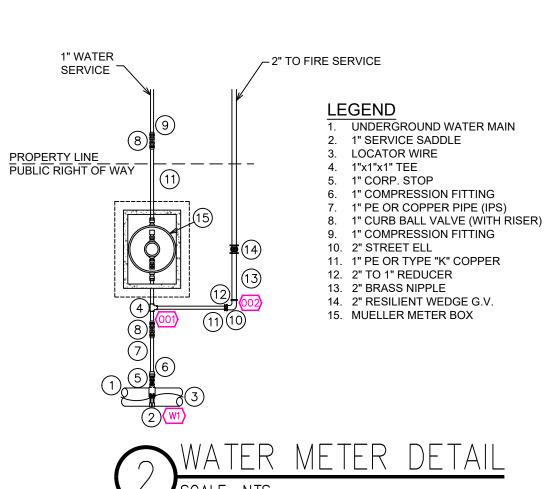


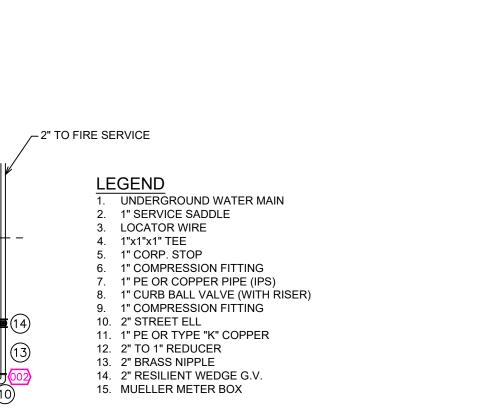


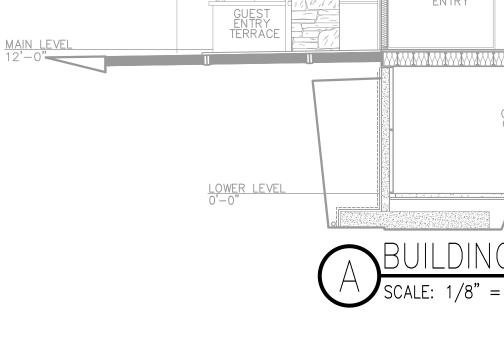



UPPER LEVEL

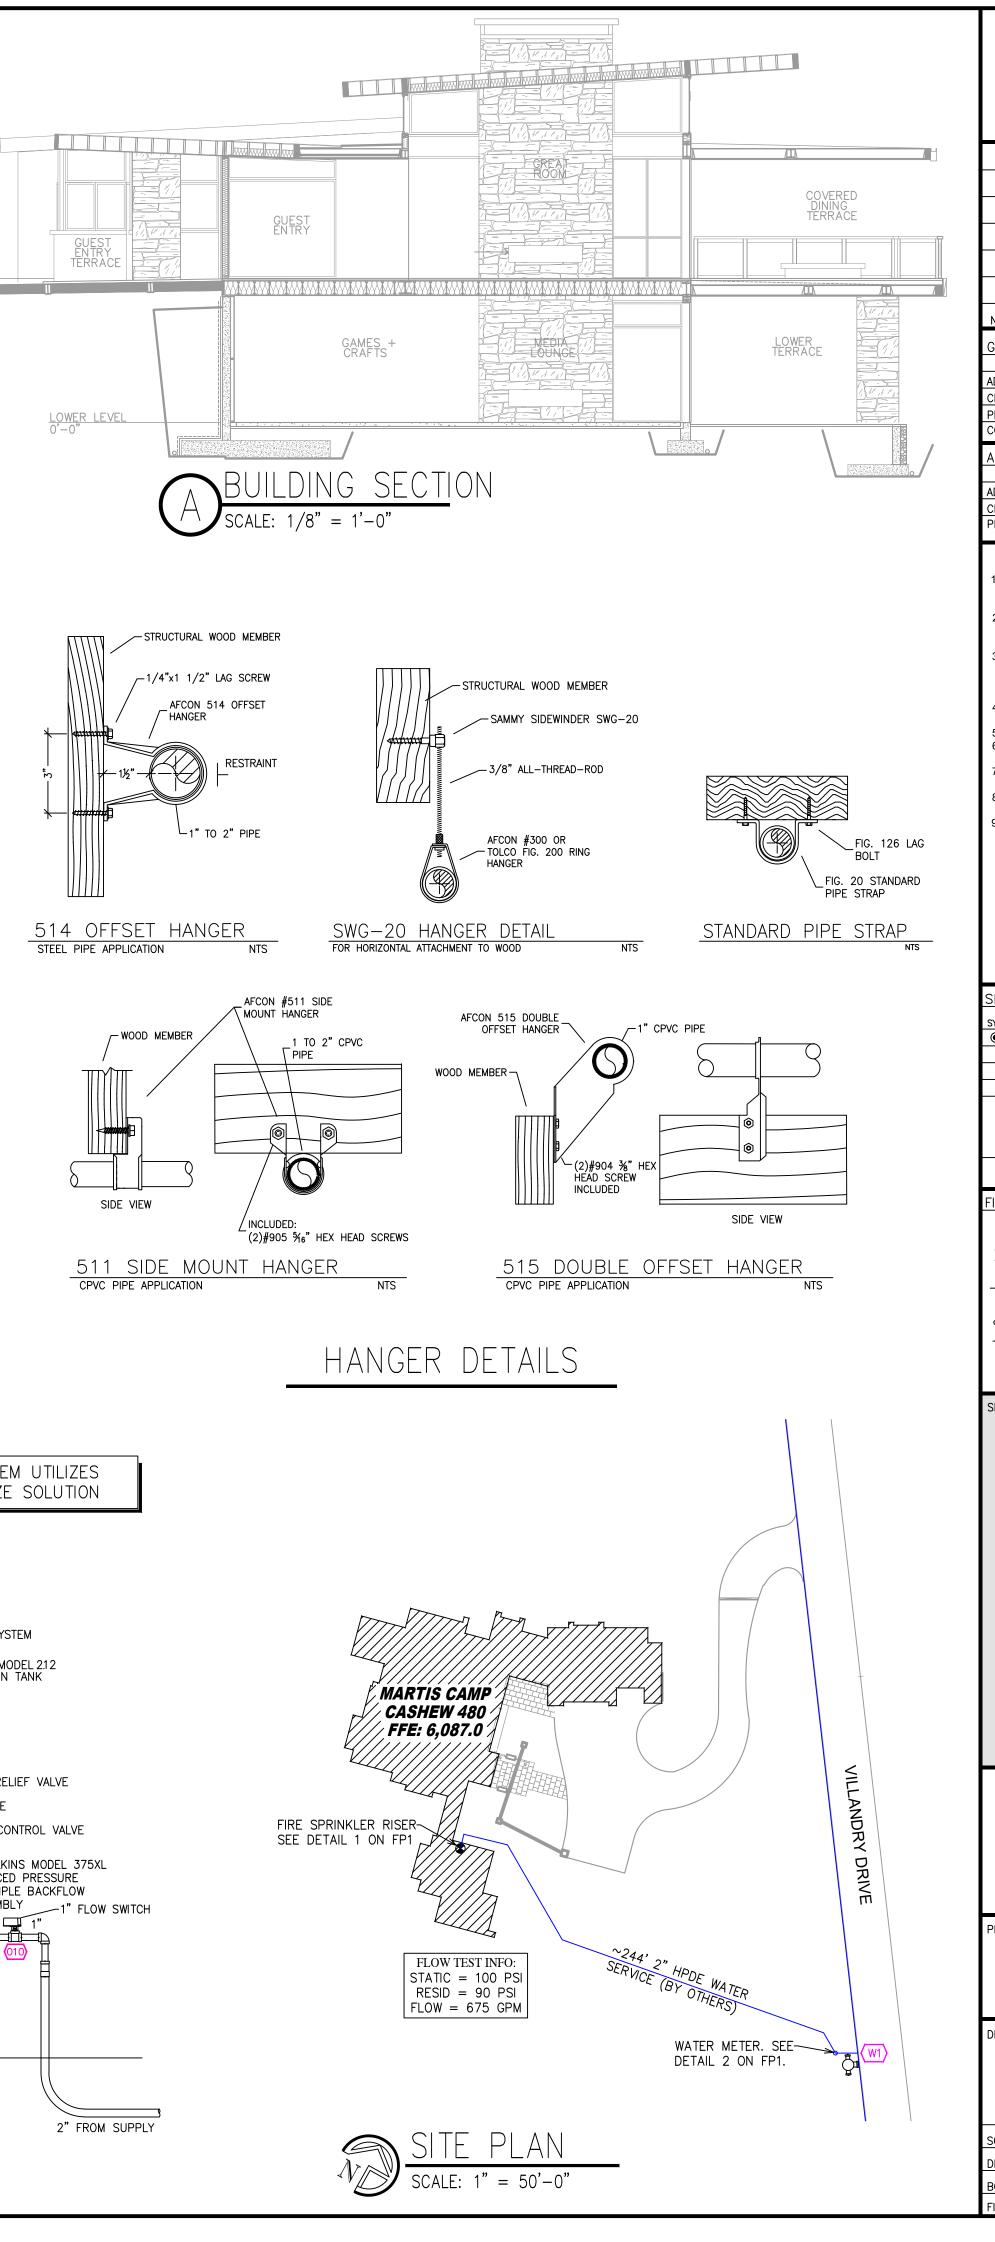


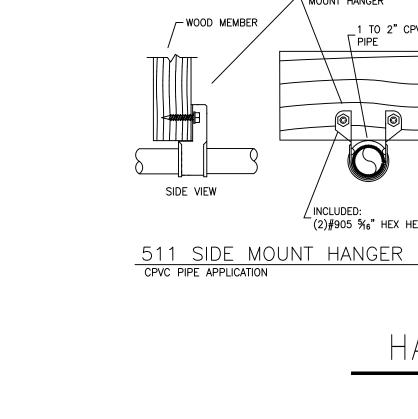


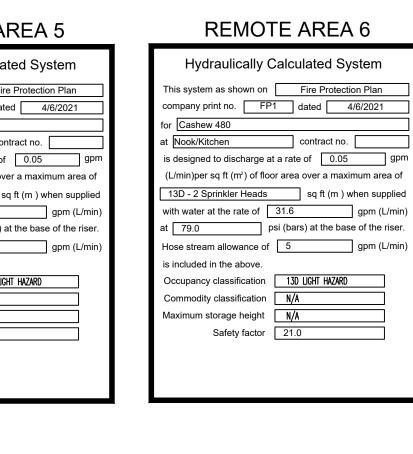


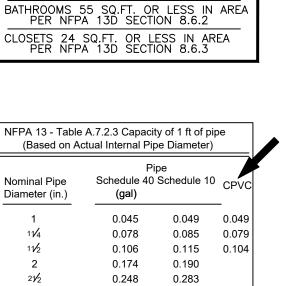


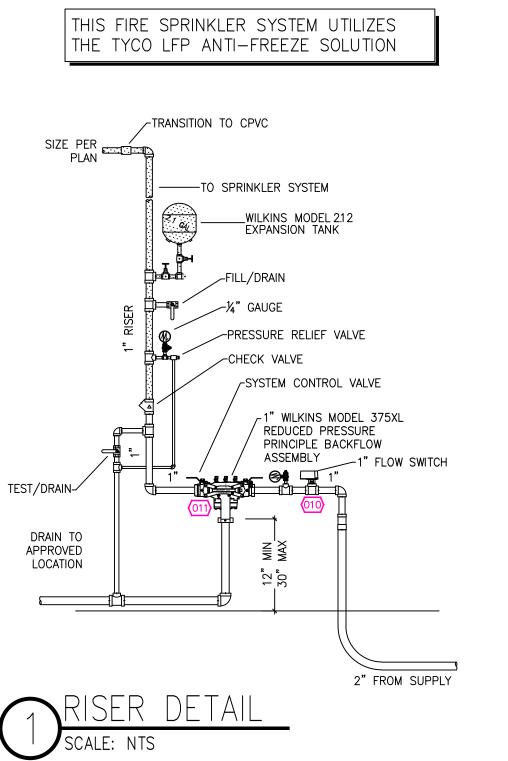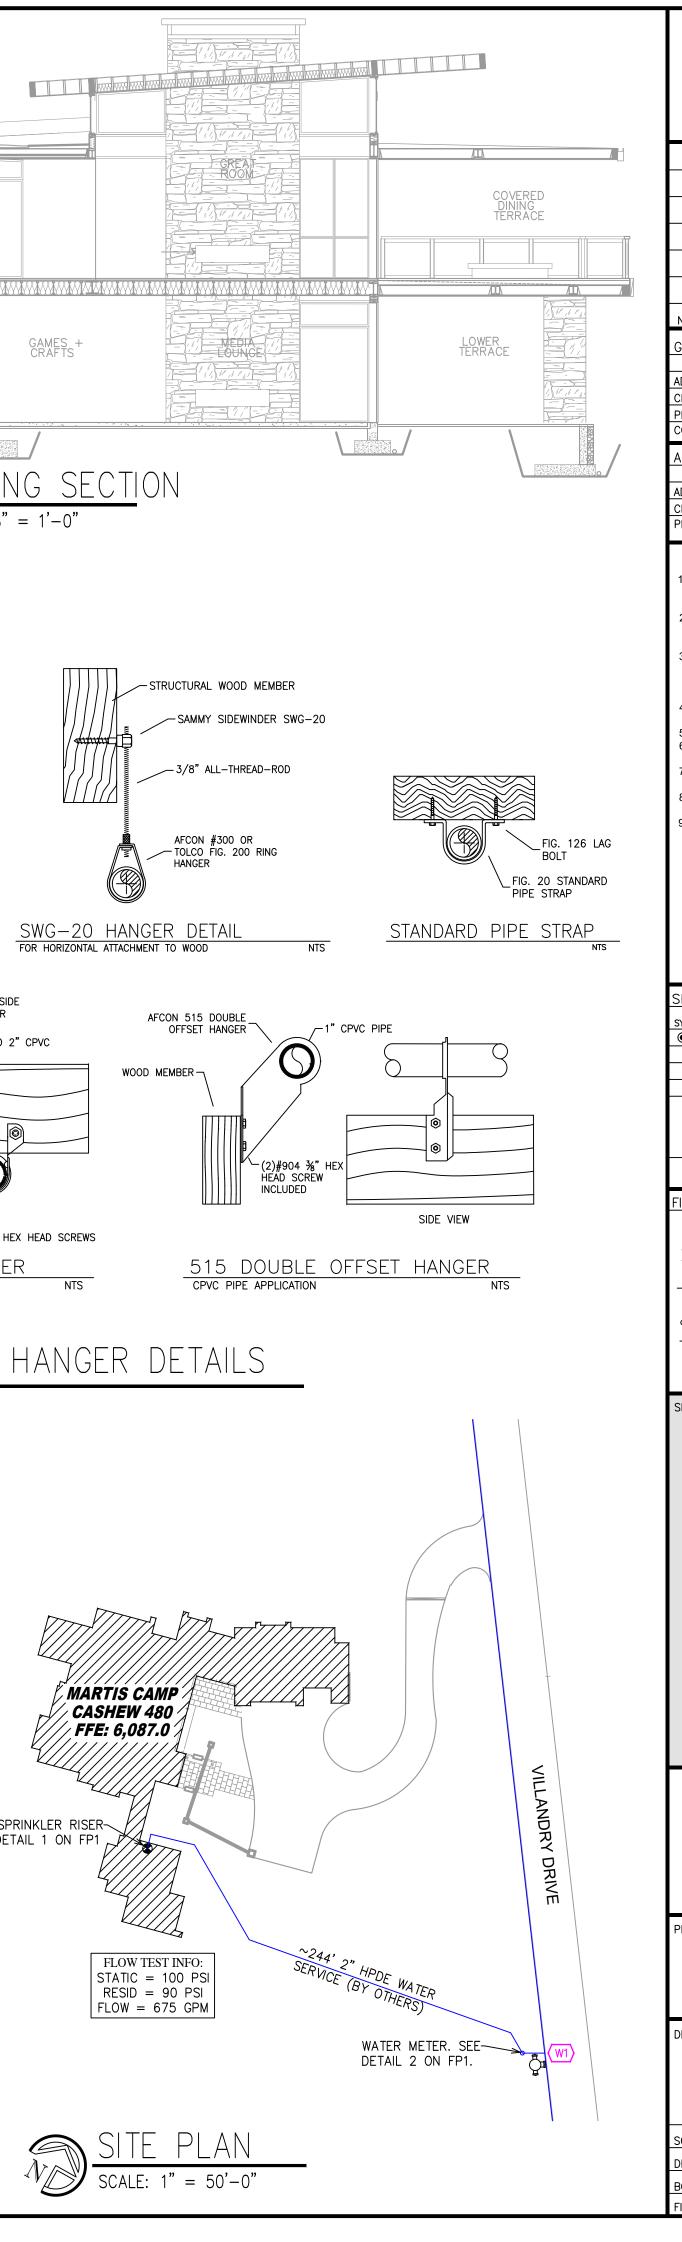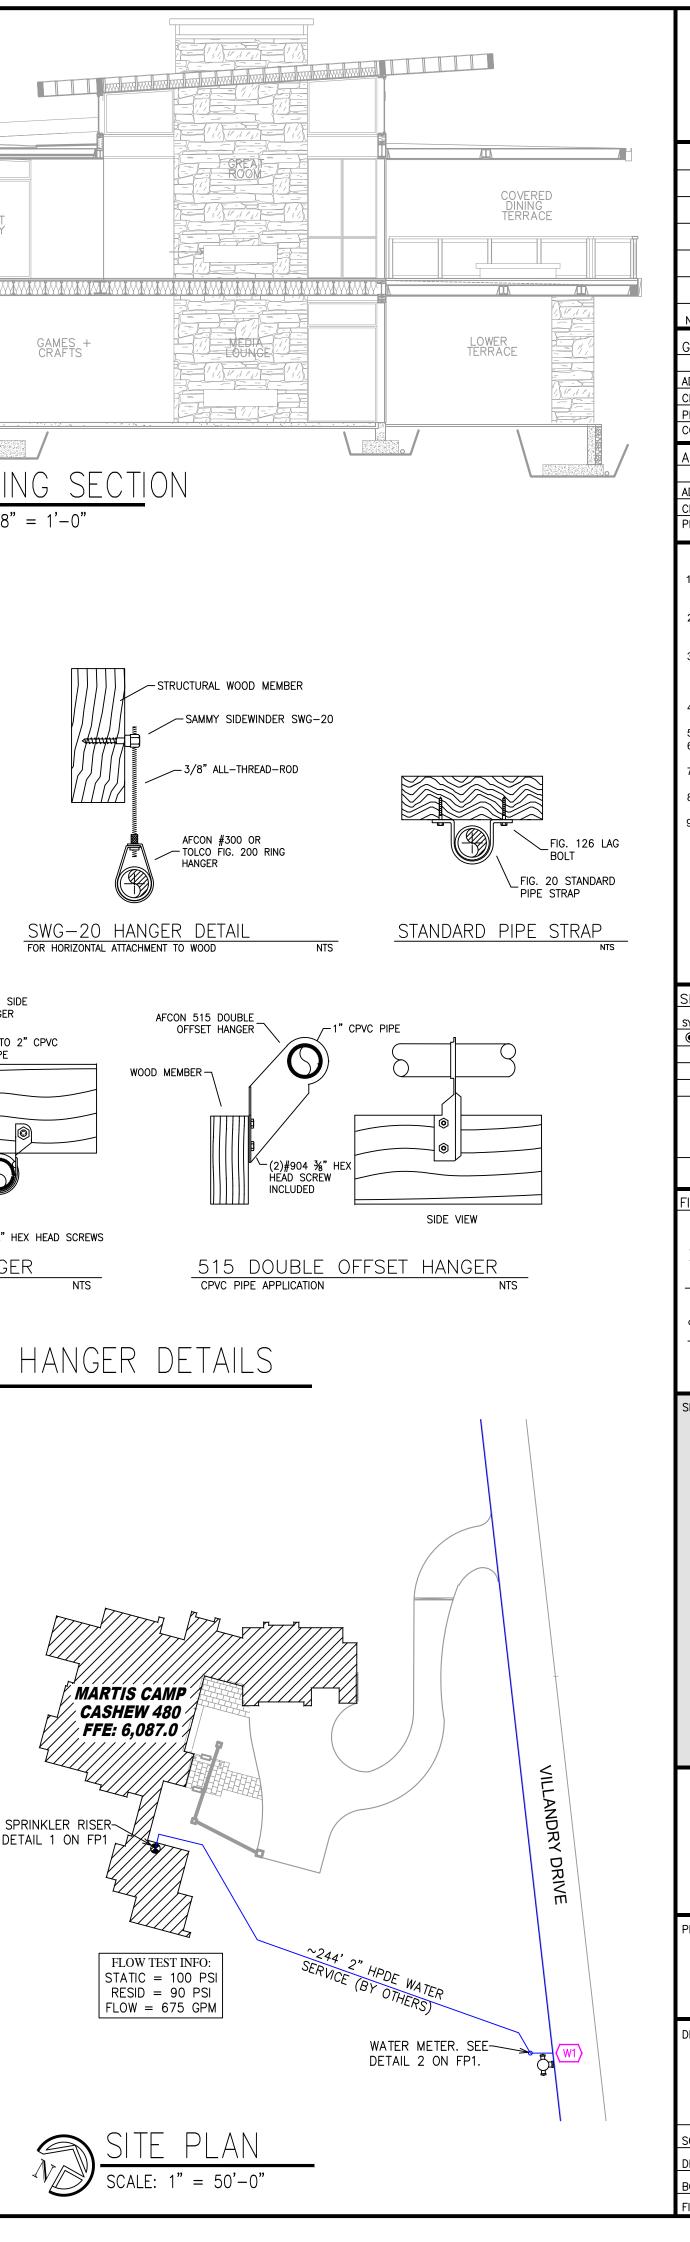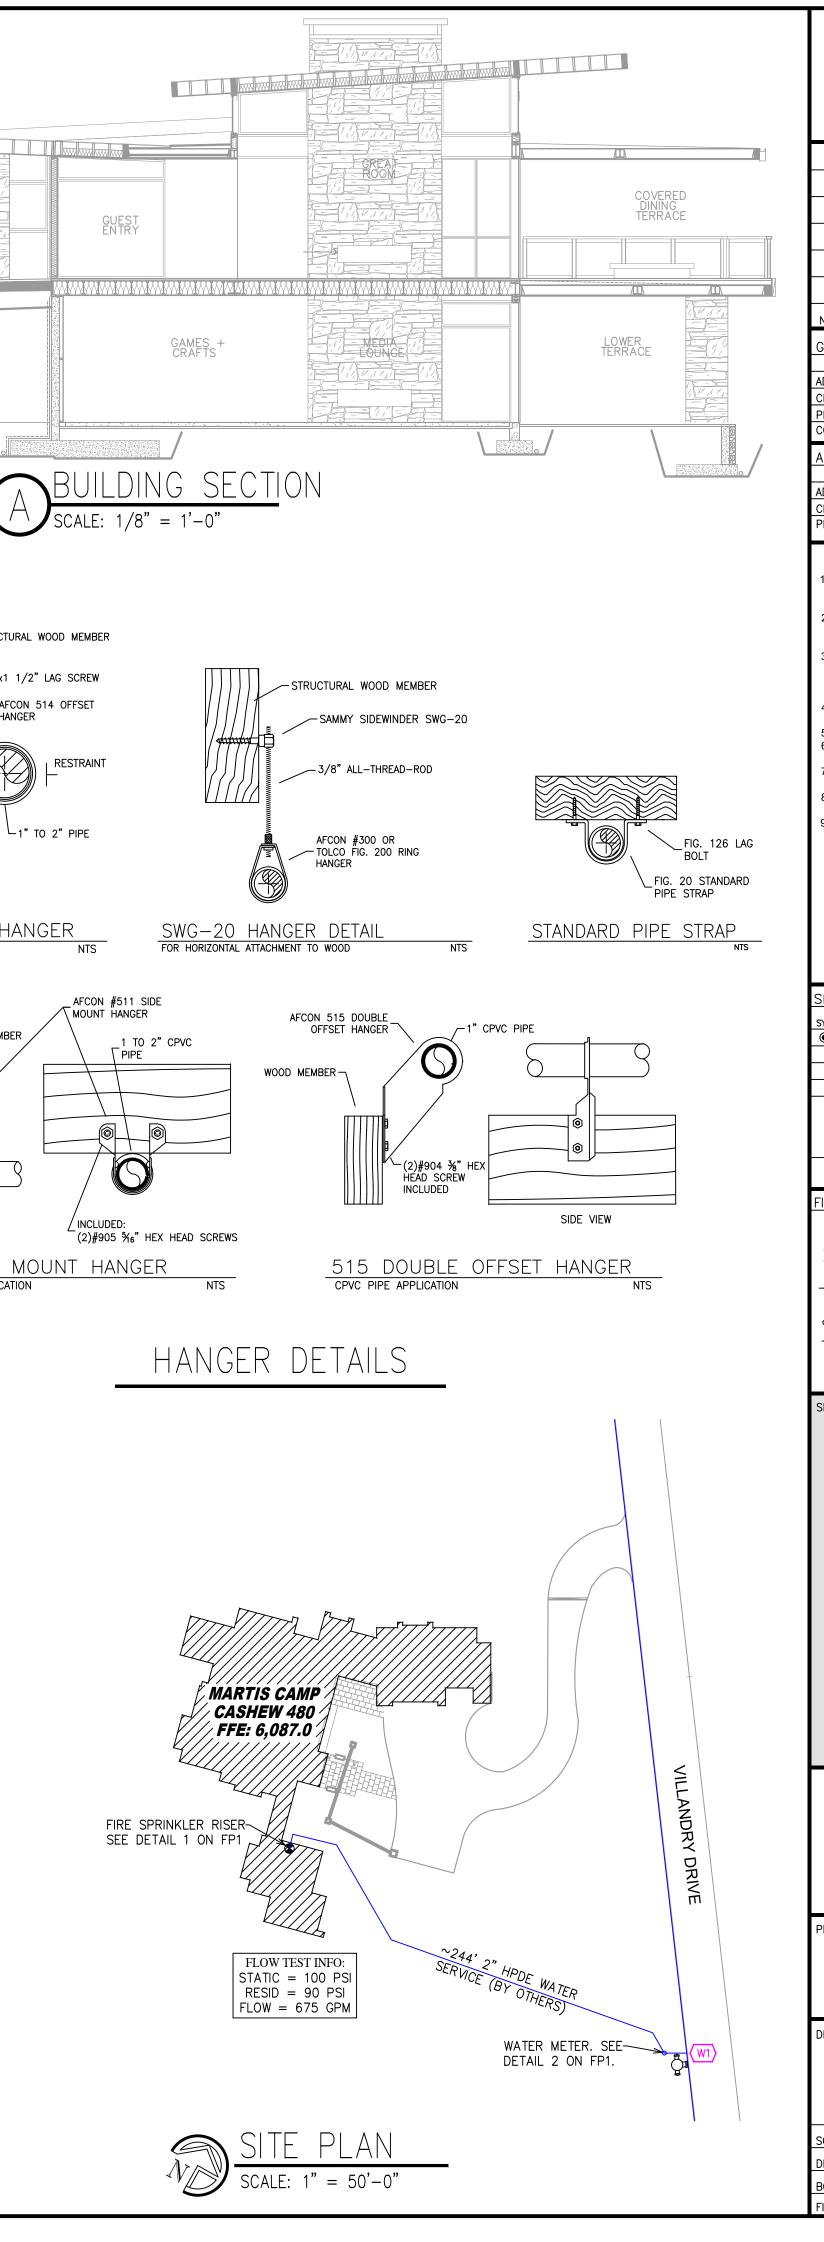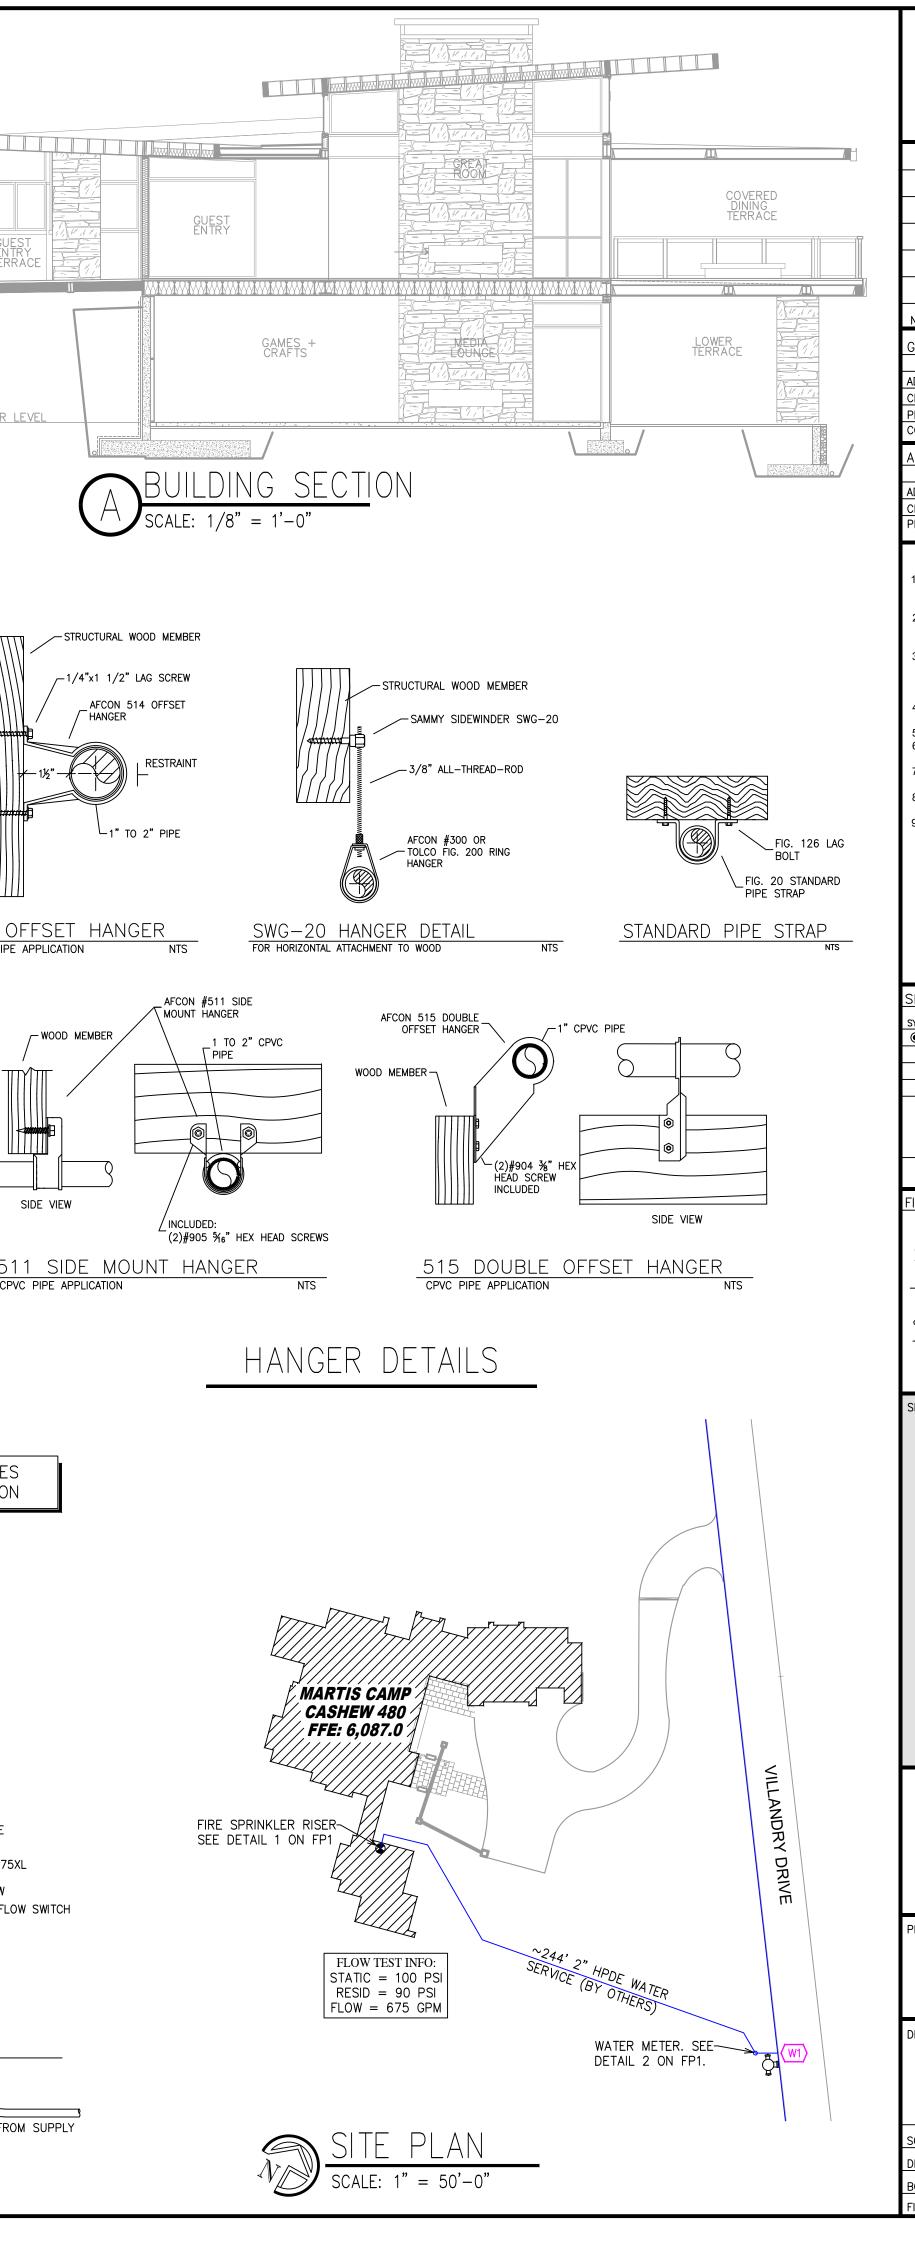





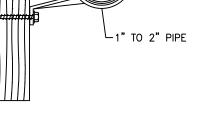


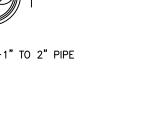


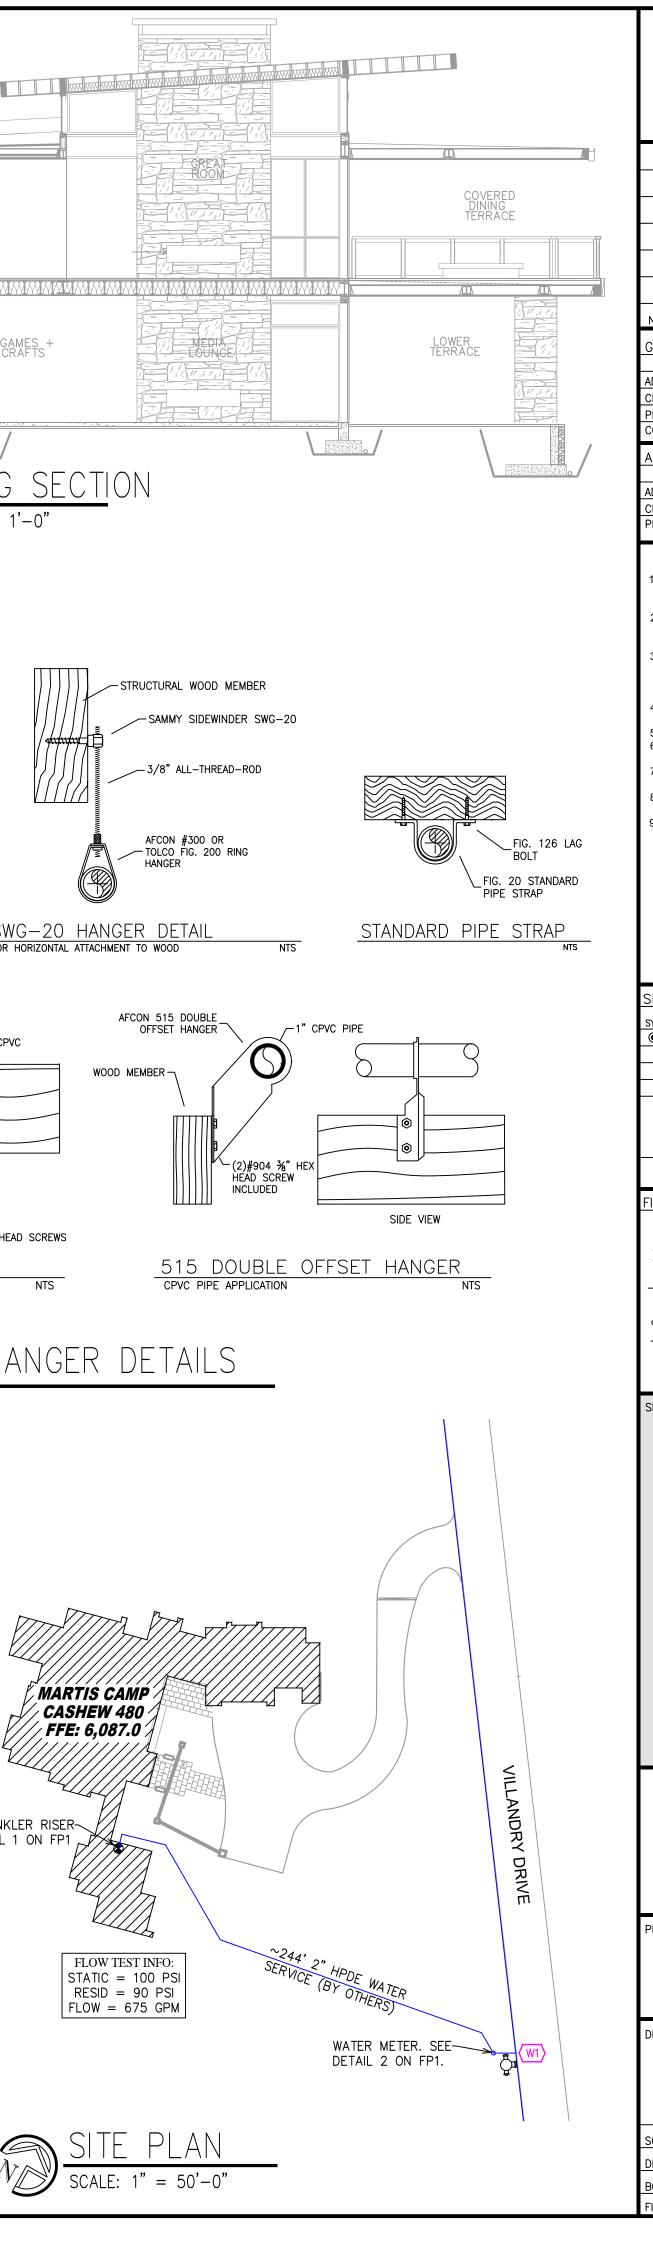




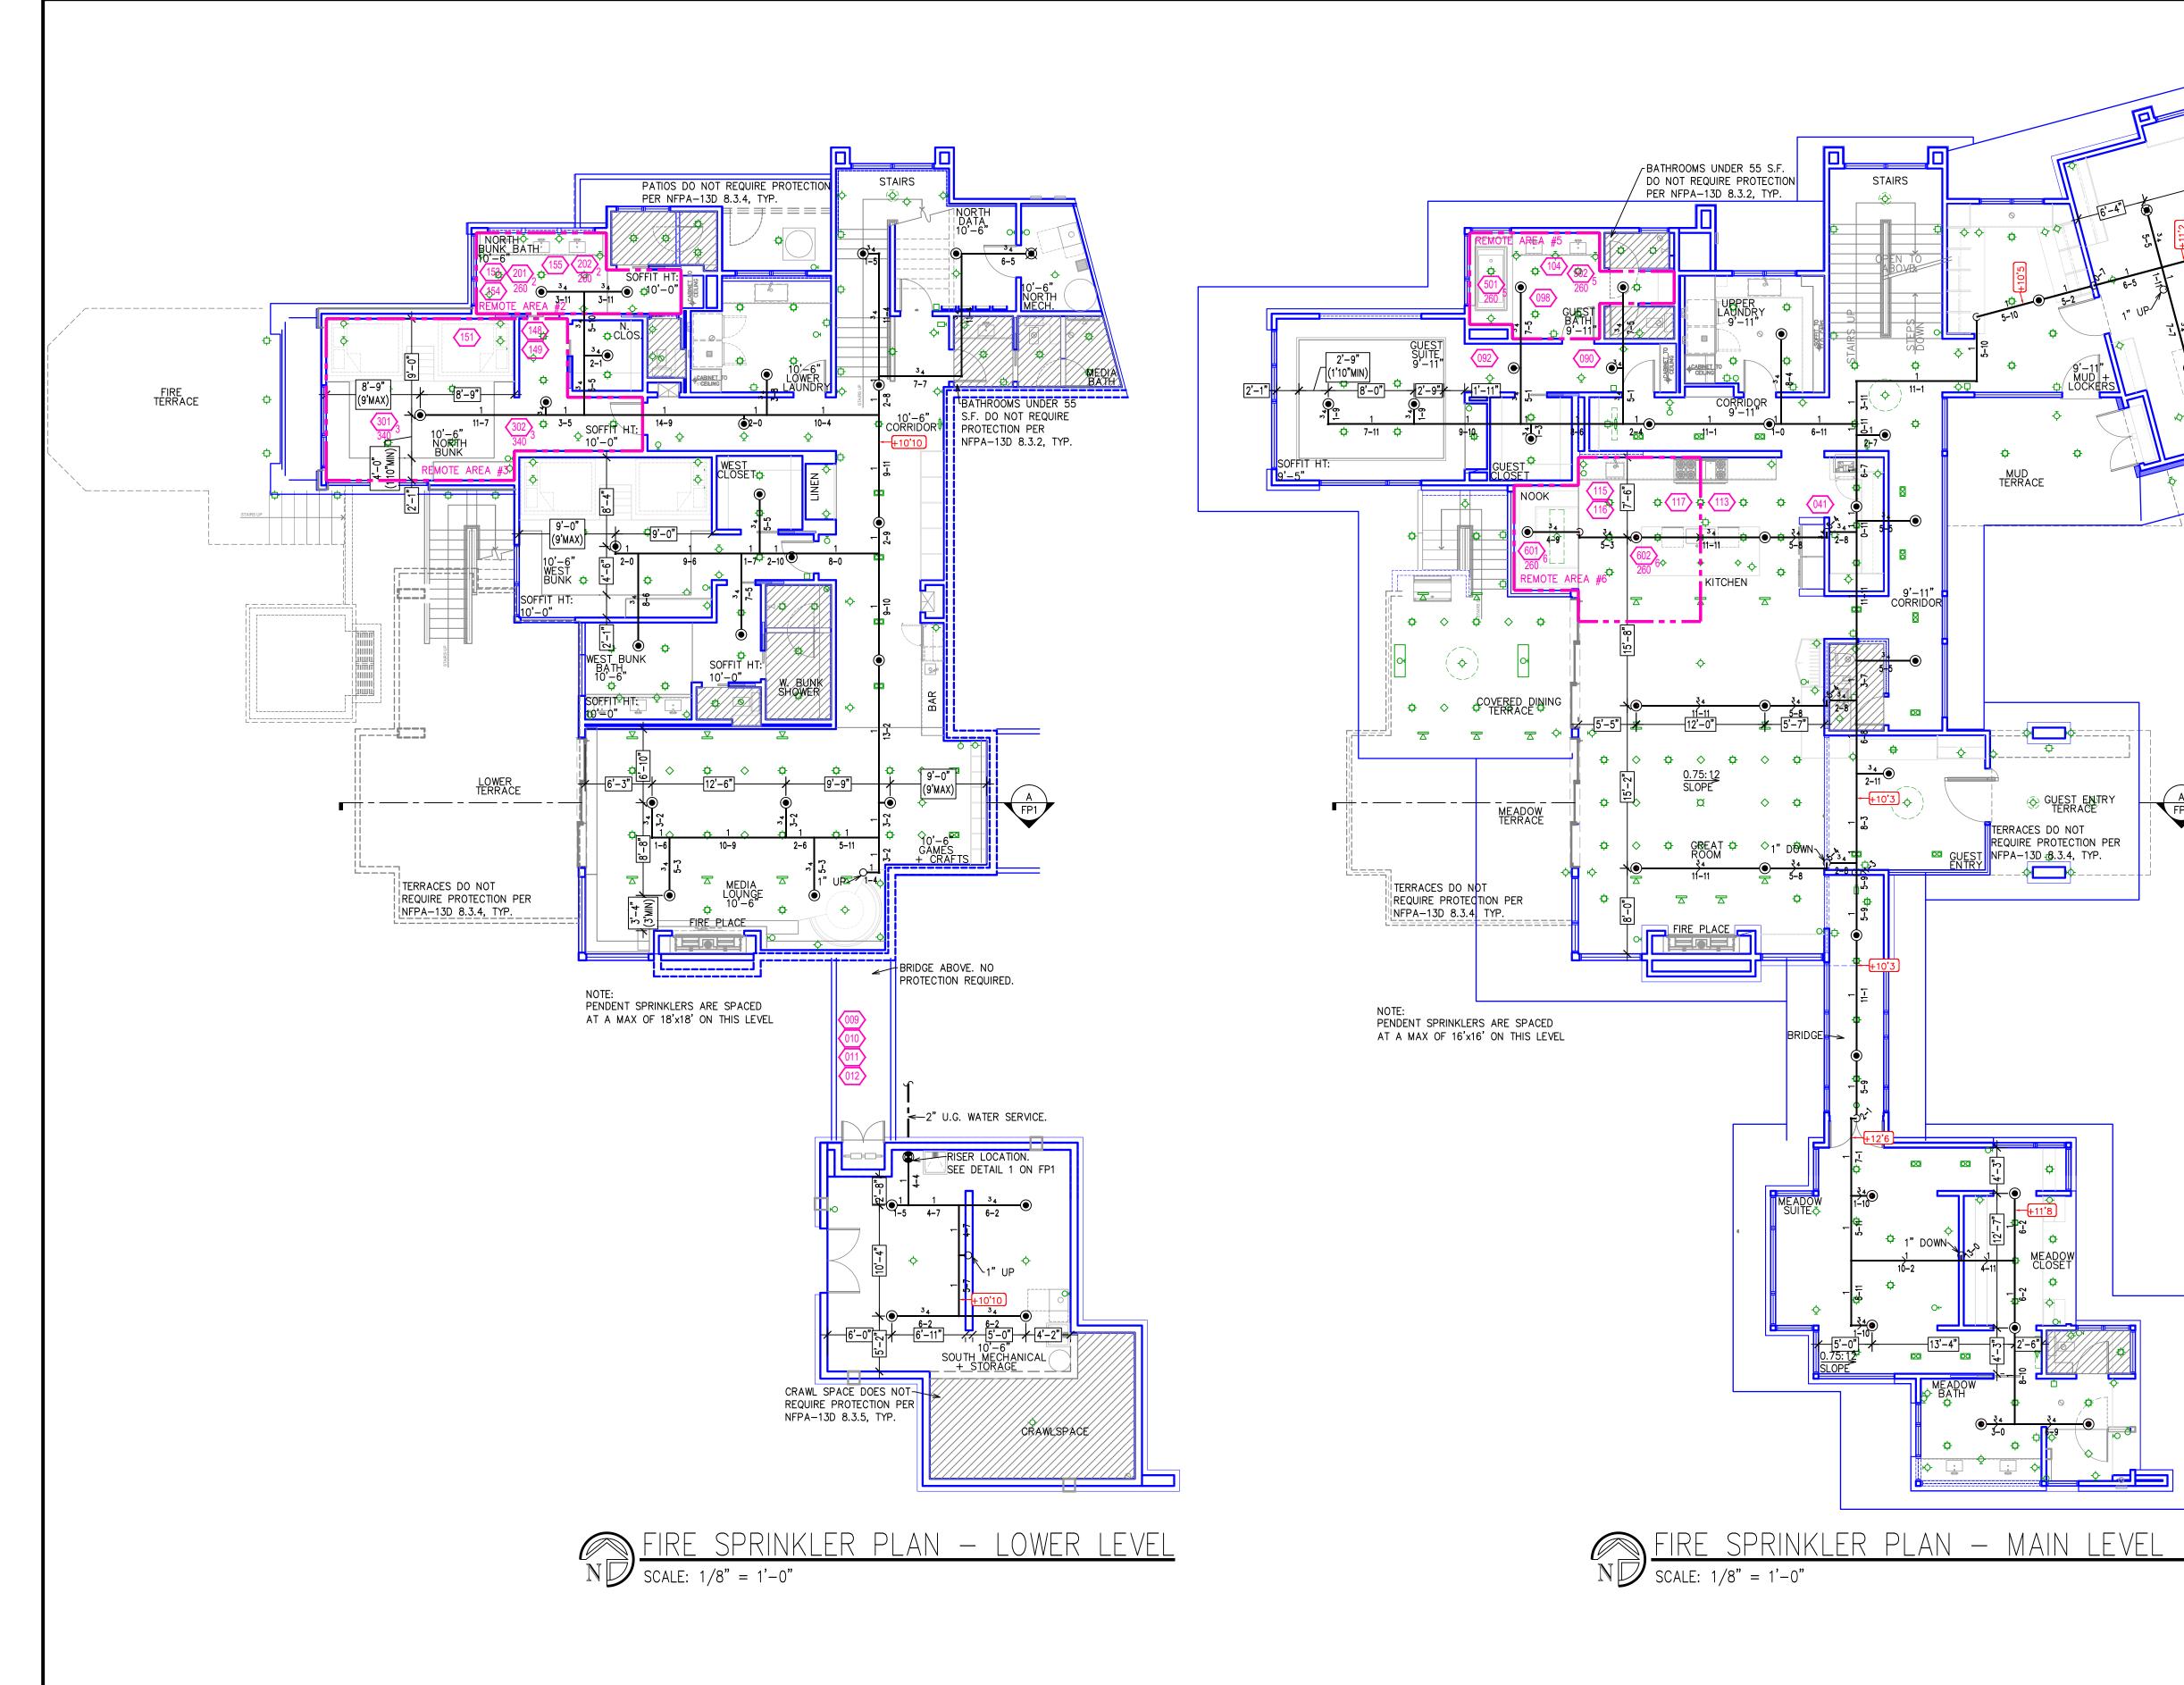








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FIRE SPRINKLER PLANS FOR CASHEW 480 MARTIS CAMP TRUCKEE, CA DRAWING TITLE: FIRE SPRINKLER PLAN SCALE: 1/8"=1'-0" JOB NO.: 4/6/2021 DRAWN BY: BORN ON DATE: 4/6/2021 FP-1	SITE	LOCA	TION:					dry Dr,			
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BORN ON DATE: 4/6/2021 FP-1				3"=1'-C)"				4/6/2	021	
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		 AUTOMATIC SPRINKLER RISER ★13" ELEV. BELOW DECK OR 1 ★12'-9" ELEV. ABOVE FINISHED F → CHANGE ELEVATION UP → CHANGE ELEVATION UN → C									
		PROJECT DRAWING SCALE: DRAWN E BORN OF	TITLE: F 1/8"=	IRE -1'-0"	SF	SHI MARTIS TRUCKI	EE, CA	480	⊃ ₄/6/:		